




EAST COAST HEIGHTS LIMITED
PROPOSED 17 LOT RESIDENTIAL SUBDIVISION
53 SMALL ROAD, SILVERDALE

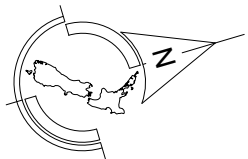

SITE LOCATION

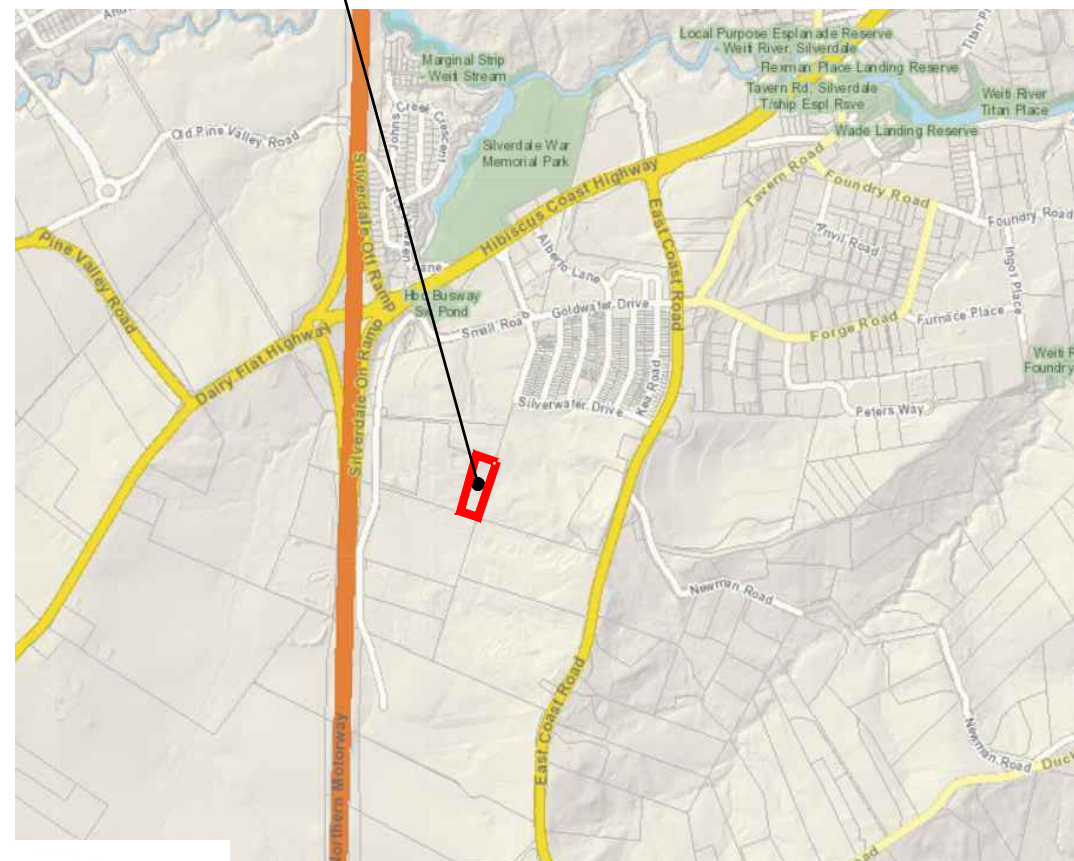

SITE LOCALITY PLAN

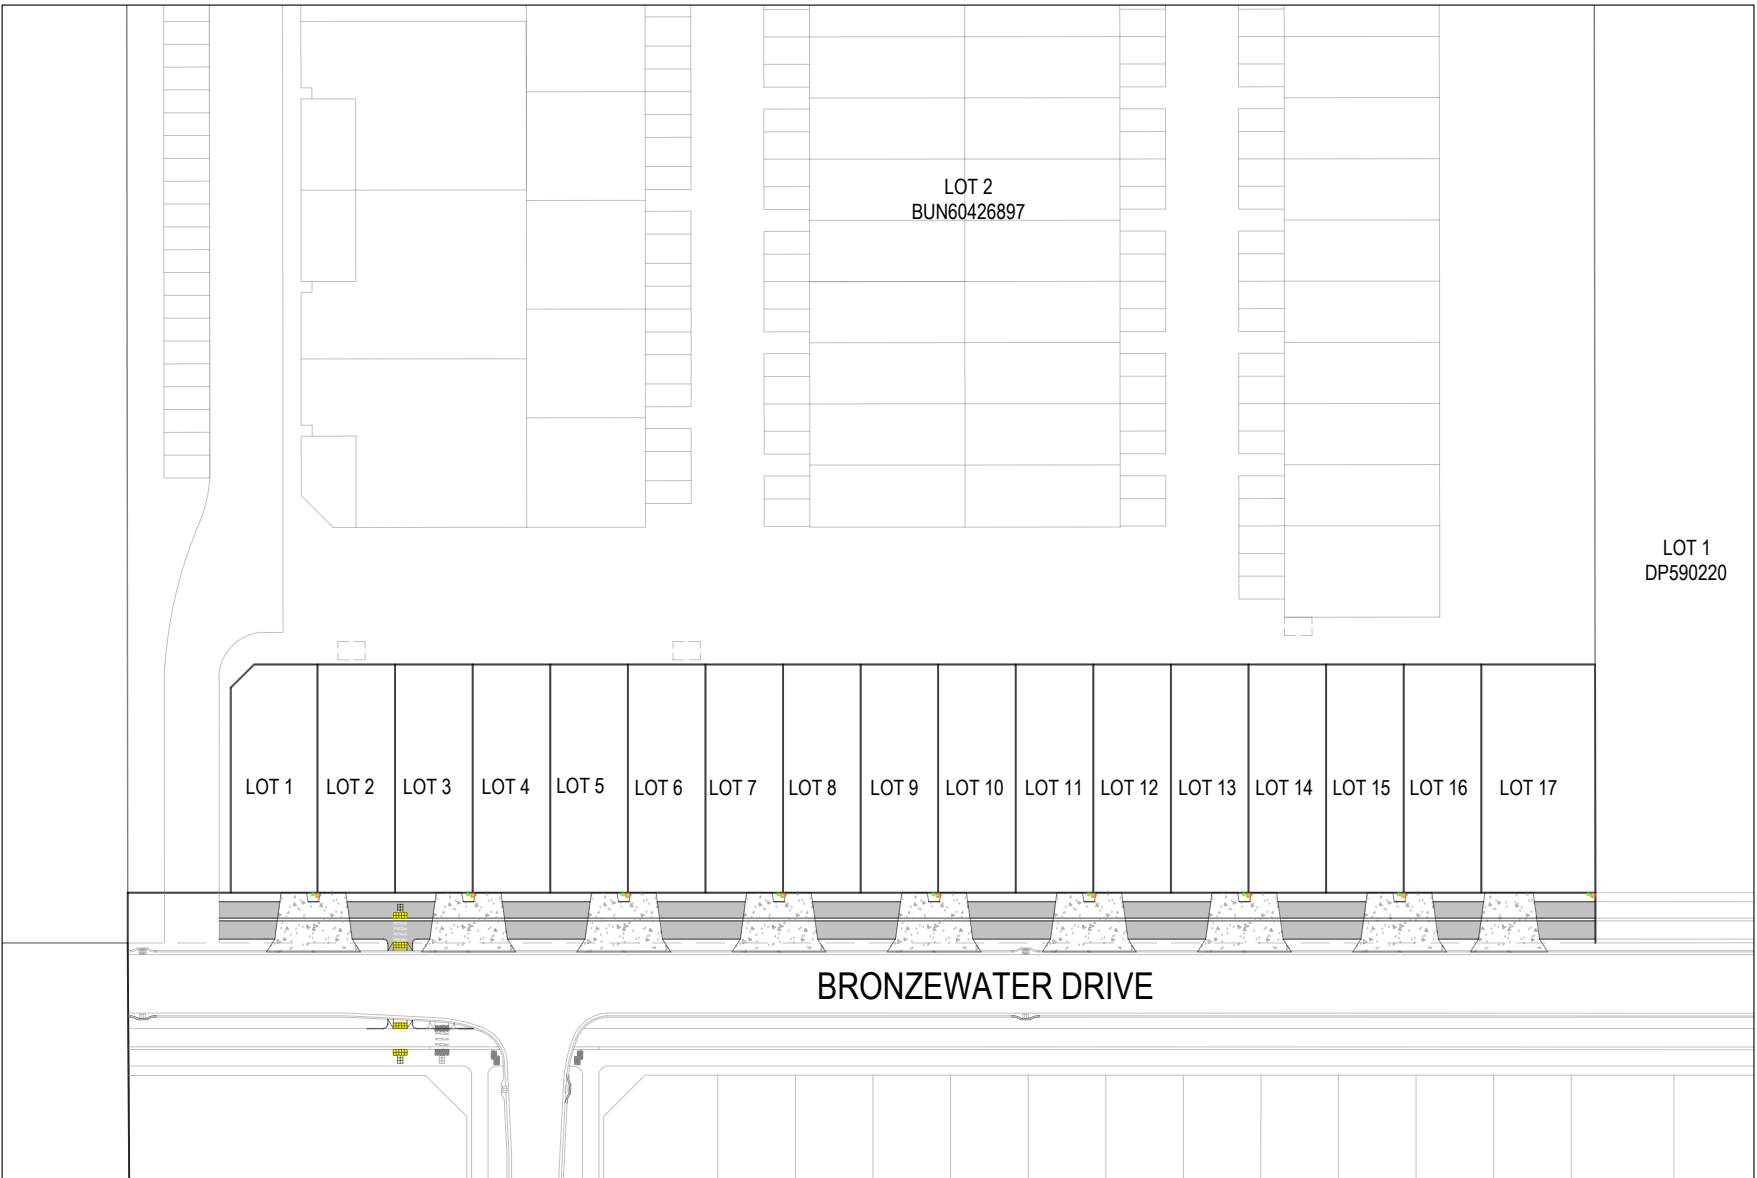

NOT FOR CONSTRUCTION
FOR RESOURCE CONSENT PURPOSE

RESOURCE CONSENT DRAWINGS:

PRELIMINARY & GENERAL

PG101	COVER SHEET
PG102	CONTENTS PAGE
PG103	EXISTING SITE PLAN
PG104	PROPOSED DEVELOPMENT PLAN

EARTHWORKS

EW201	PROPOSED CONTOUR PLAN
EW202	PROPOSED CUT & FILL DEPTH CONTOUR PLAN
EW203	EROSION & SEDIMENT CONTROL PLAN
EW204-206	EROSION & SEDIMENT CONTROL DETAILS
EW207	PROPOSED RETAINING WALL PLAN

ROADING

RD301	PROPOSED ROADING PLAN
RD302	TYPICAL VEHICLE CROSSING DETAIL
RD303	TYPICAL ROAD CROSS SECTION PLAN

STORMWATER

SW401	PROPOSED STORMWATER OVERVIEW PLAN
SW402	PROPOSED STORMWATER PLAN


WASTEWATER

WW501	PROPOSED WASTEWATER OVERVIEW PLAN
WW502	PROPOSED WASTEWATER PLAN

WATER SUPPLY

WS601	PROPOSED WATER SUPPLY PLAN
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FOR RESOURCE CONSENT PURPOSE

REV.	DESCRIPTION	CHECK	APP'D	DATE	SCALE	N.T.S	CLIENT			SITE ADDRESS	DRAWING NUMBER	DATE	REVISION	 Ph: 09 426 6552 Web: www.aspireconsulting.co.nz
							NAME	DATE	EAST COAST HEIGHTS LIMITED	PROPOSED 17 LOT RESIDENTIAL SUBDIVISION 53 SMALL ROAD, SILVERDALE	1927 - RC - PG102	MAR 2025	-	
					DESIGN		MJ	03.25						
					DRAWN		KC	03.25						
					DRAWING CHECK		MJ	03.25						
					DESIGN CHECK		MJ	03.25						
					APPROVED		PF	03.25	Conditions of Use: <i>These drawings shall only be used for the purpose for which they were supplied. Do not measure off this drawing. If doubt please contact Engineer.</i>					
										DRAWING TITLE	CONTENTS PAGE			



NOTE:
ALL LEVELS IN TERMS OF LINZ DATUM:
HORIZONTAL DATUM: GEODETIC DATUM 2000
VERTICAL DATUM: NEW ZEALAND VD2016

REV.	DESCRIPTION	CHECK	APP'D	DATE	SCALE	1:750 AT A3	NAME	DATE	CLIENT	SITE ADDRESS	DRAWING NUMBER	DATE	REVISION	
									EAST COAST HEIGHTS LIMITED	PROPOSED 17 LOT RESIDENTIAL SUBDIVISION 53 SMALL ROAD, SILVERDALE	1927 - RC - PG103	MAR 2025	-	
						DESIGN	MJ	03.25						
						DRAWN	KC	03.25						
						DRAWING CHECK	MJ	03.25						
						DESIGN CHECK	MJ	03.25						
						APPROVED	PF	03.25	Conditions of Use: <small>These drawings shall only be used for the purpose for which they were supplied. Do not measure off this drawing. If doubt please contact Engineer.</small>		DRAWING TITLE		EXISTING SITE PLAN	

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Web: www.aspireconsulting.co.nz



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FOR RESOURCE CONSENT PURPOSE

NOTE:
ALL LEVELS IN TERMS OF LINZ DATUM:
HORIZONTAL DATUM: GEODETIC DATUM 2000
VERTICAL DATUM: NEW ZEALAND VD2016

REV.	DESCRIPTION	CHECK	APP'D	DATE	SCALE	1:750 AT A3
					NAME	DATE
					DESIGN	MJ 03.25
					DRAWN	KC 03.25
					DRAWING CHECK	MJ 03.25
					DESIGN CHECK	MJ 03.25
					APPROVED	PF 03.25

CLIENT
EAST COAST HEIGHTS LIMITED
Conditions of Use: These drawings shall only be used for the purpose for which they were supplied. Do not measure off this drawing. If doubt please contact Engineer.

SITE ADDRESS
PROPOSED 17 LOT RESIDENTIAL SUBDIVISION 53 SMALL ROAD, SILVERDALE
DRAWING TITLE
PROPOSED DEVELOPMENT PLAN

DRAWING NUMBER
1927 - RC - PG104
DATE
MAR 2025
REVISION
-



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NOTE:
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HORIZONTAL DATUM: GEODETIC DATUM 2000
VERTICAL DATUM: NEW ZEALAND VD2016

REV.	DESCRIPTION	CHECK	APP'D	DATE	SCALE	1:750 AT A3
A	PLATFORM LEVELS RAISED	MJ	PF	24.9.25		
					DESIGN	MJ 03.25
					DRAWN	KC 03.25
					DRAWING CHECK	MJ 03.25
					DESIGN CHECK	MJ 03.25
					APPROVED	PF 03.25

CLIENT
EAST COAST HEIGHTS LIMITED

Conditions of Use:
These drawings shall only be used for the purpose for which they were supplied. Do not measure off this drawing. If doubt please contact Engineer.

SITE ADDRESS
PROPOSED 17 LOT RESIDENTIAL SUBDIVISION
53 SMALL ROAD,
SILVERDALE

DRAWING TITLE
PROPOSED CONTOUR PLAN

DRAWING NUMBER
1927 - RC - EW201

DATE
MAR 2025

REVISION
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LEGEND

TOTAL EARTHWORKS AREA: 3,768m²

-3.0

-2.0

CUT VOLUME: 360m³
MAX CUT DEPTH -2.5

-3.0

-2.0

FILL VOLUME: 2150m³
MAX FILL DEPTH 2.8m

NOT FOR CONSTRUCTION
FOR RESOURCE CONSENT PURPOSE

NOTE:
ALL LEVELS IN TERMS OF LINZ DATUM:
HORIZONTAL DATUM: GEODETIC DATUM 2000
VERTICAL DATUM: NEW ZEALAND VD2016

REV.	DESCRIPTION	CHECK	APP'D	DATE	SCALE 1:750 AT A3		
A	PLATFORM LEVELS RAISED	MJ	PF	24.9.25	NAME	DATE	
					DESIGN	MJ	03.25
					DRAWN	KC	03.25
					DRAWING CHECK	MJ	03.25
					DESIGN CHECK	MJ	03.25
					APPROVED	PF	03.25

CLIENT
EAST COAST HEIGHTS LIMITED
Conditions of Use: These drawings shall only be used for the purpose for which they were supplied. Do not measure off this drawing. If doubt please contact Engineer.

SITE ADDRESS
PROPOSED 17 LOT RESIDENTIAL SUBDIVISION 53 SMALL ROAD, SILVERDALE
DRAWING TITLE
PROPOSED CUT TO FILL DEPTH CONTOUR PLAN


DRAWING NUMBER	
1927 - RC - EW202	
DATE	REVISION
MAR 2025	-

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CONSULTING ENGINEERS


Ph: 09 426 6552
Web: www.aspireconsulting.co.nz




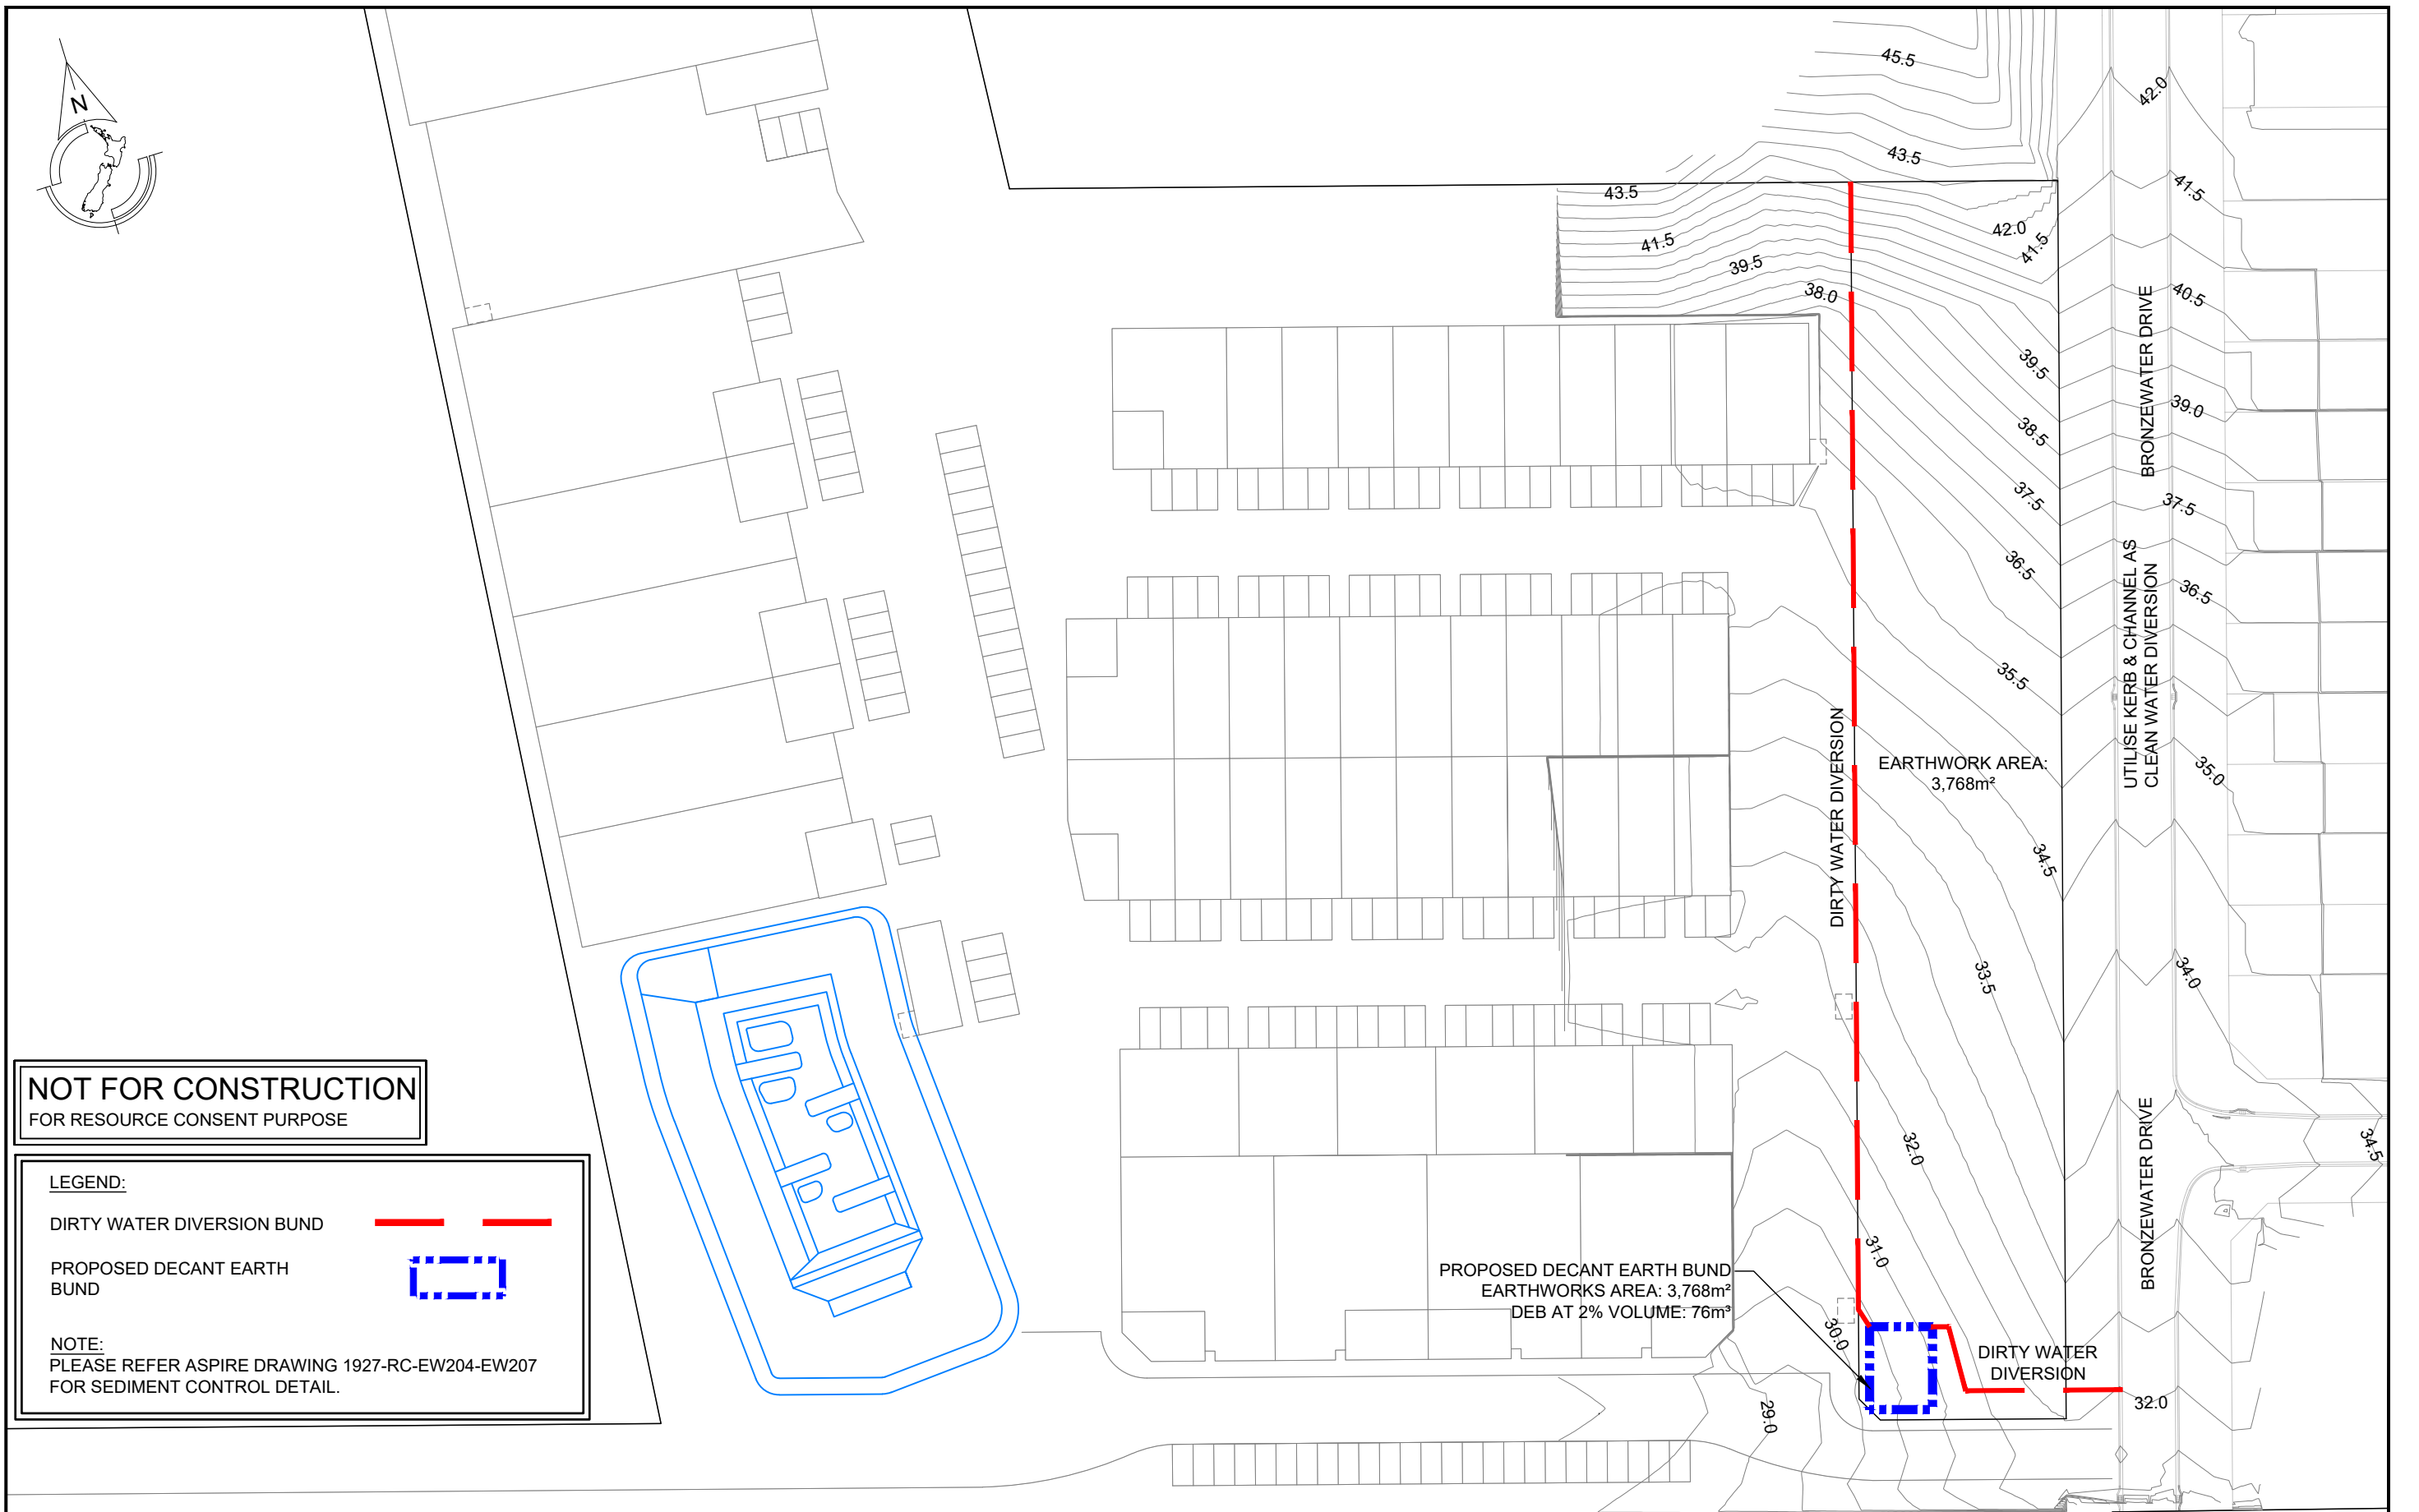


NOTE:
ALL LEVELS IN TERMS OF LINZ DATUM:
HORIZONTAL DATUM: GEODETIC DATUM 2000
VERTICAL DATUM: NEW ZEALAND VD2016

REV.	DESCRIPTION	CHECK	APPD	DATE	SCALE	1:750 AT A3		CLIENT	SITE ADDRESS	DRAWING NUMBER	
						NAME	DATE	EAST COAST HEIGHTS LIMITED	PROPOSED 17 LOT RESIDENTIAL SUBDIVISION 53 SMALL ROAD, SILVERDALE	1927 - RC - EW203	
					DESIGN	MJ	03.25				
					DRAWN	KC	03.25				
					DRAWING CHECK	MJ	03.25				
					DESIGN CHECK	MJ	03.25				
					APPROVED	PF	03.25	Conditions of Use: <i>These drawings shall only be used for the purpose for which they were supplied. Do not measure off this drawing. If doubt please contact Engineer.</i>	DRAWING TITLE	DATE	REVISION
								PROPOSED SEDIMENT AND EROSION CONTROL PLAN	MAR 2025	-	




Ph: 09 426 6552
Web: www.aspireconsulting.co.nz

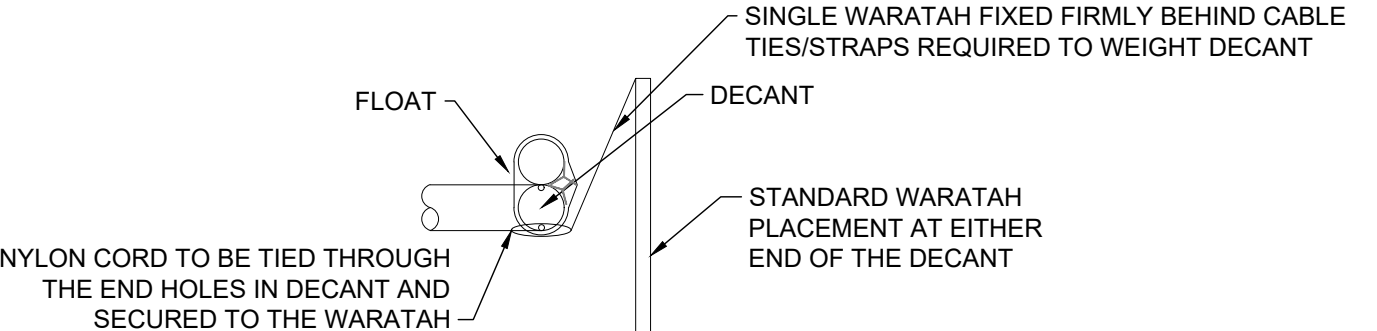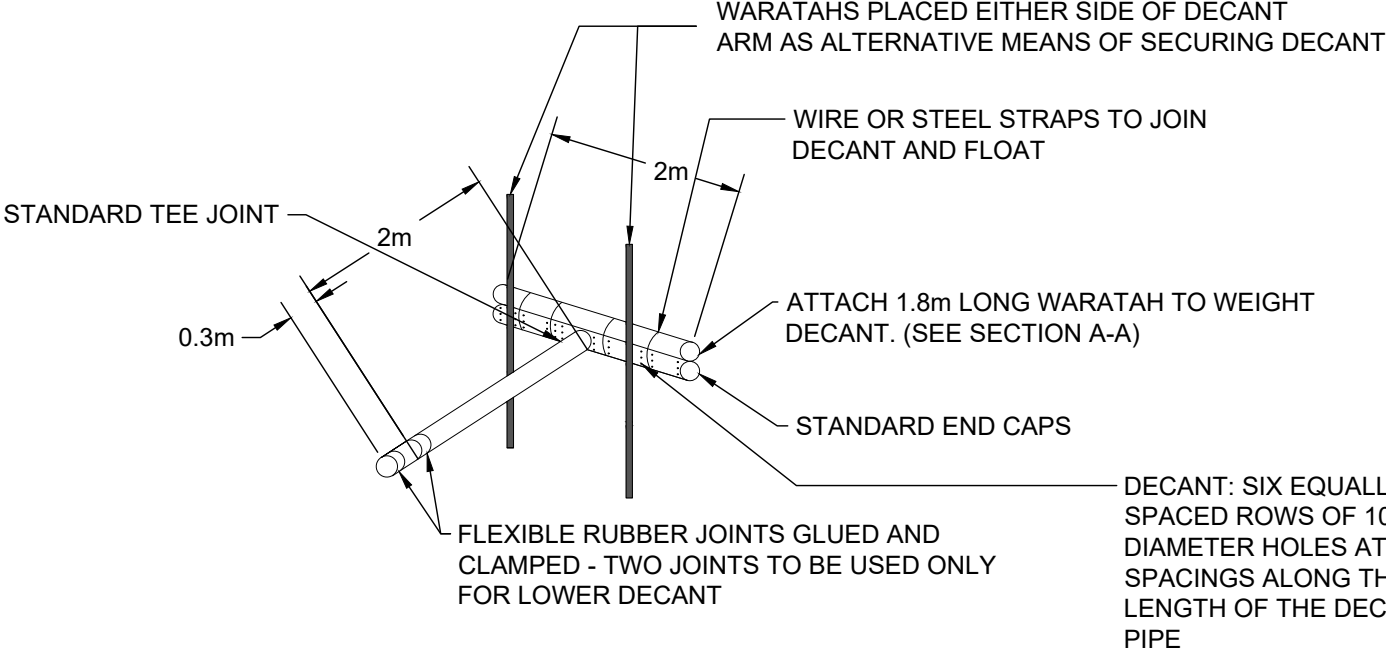

DECANTING DEVICE SIZING:	
CONTRIBUTING AREA	STORAGE VOLUME 2%
200m ²	4m ³
400m ²	8m ³
600m ²	12m ³
800m ²	16m ³
1000m ²	20m ³
1200m ²	24m ³
1400m ²	28m ³
1600m ²	32m ³
1800m ²	36m ³
2000m ²	40m ³
2200m ²	44m ³
2400m ²	48m ³
2600m ²	52m ³
2800m ²	56m ³
3000m ²	60m ³

STANDARD T-BAR DESIGN SCHEMATIC

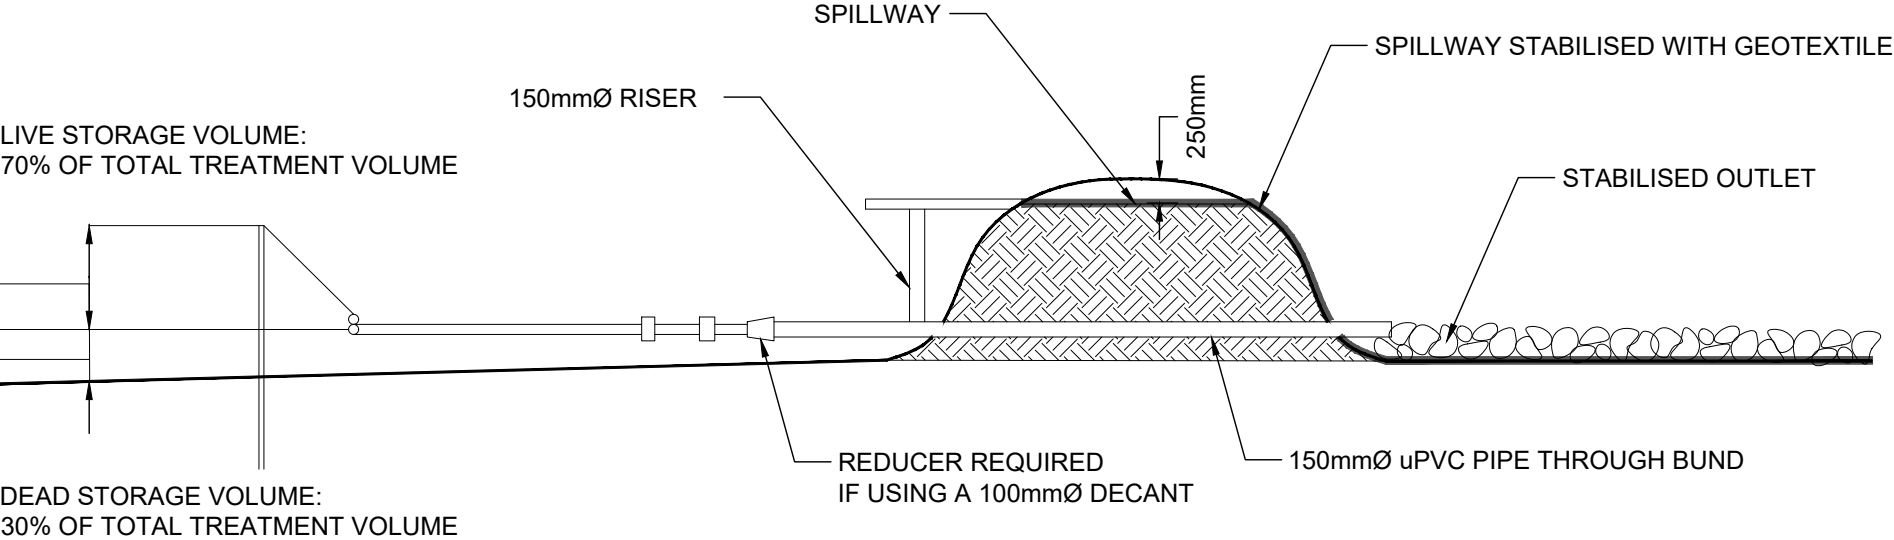

DECANTING EARTH BUND CROSS-SECTION

DEB SIZING:

- DEB SIZING IS BASED ON CONTRIBUTING CATCHMENT AREA
- DECANTING EARTH BUND TO HAVE A MINIMUM VOLUME OF 2% OF THE CONTRIBUTING CATCHMENT AREA (20m³ FOR EACH 1,000m²)
- THE SLOPE ANGLE IS DETERMINED BY THE SLOPE IMMEDIATELY ABOVE THE DEB, OR BY THE AVERAGE SLOPE OVER THE CONTRIBUTING CATCHMENT, WHICHEVER IS GREATER. THE SLOPE ANGLE SHOULD ALSO BE THE GREATER OF THE PRE- OR POST- CONSTRUCTION SLOPE.
- THE ABOVE CALCULATION DEFINES THE TOTAL STORAGE VOLUME WHICH IS MEASURED FROM THE BASE OF THE DEB TO THE TOP OF THE PRIMARY SPILLWAY.
- BASE OF THE DEB TO BE MINIMUM OF 2m WIDE
- LENGTH-TO-WIDTH RATIO TO BE NO LESS THAN 3:1 AND NO GREATER THAN 5:1. LENGTH TO WIDTH RATIO IS MEASURED AT THE HEIGHT OF THE PRIMARY SPILLWAY.
- THE LENGTH OF THE DEB IS MEASURED AS THE DISTANCE BETWEEN THE INLET AND THE OUTLET. THE LENGTH BETWEEN THE INLET AND THE OUTLET SHOULD BE A MINIMUM OF 5m.

REV.	DESCRIPTION	CHECK	APP'D	DATE	SCALE	N.T.S	NAME	DATE


CLIENT	EAST COAST HEIGHTS LIMITED
Conditions of Use:	These drawings shall only be used for the purpose for which they were supplied. Do not measure off this drawing. If doubt please contact Engineer.

SITE ADDRESS	PROPOSED 17 LOT RESIDENTIAL SUBDIVISION 53 SMALL ROAD, SILVERDALE
DRAWING TITLE	PROPOSED EROSION & SEDIMENT CONTROL DETAILS 1


DRAWING NUMBER	1927 - RC - EW204
DATE	MAR 2025
REVISION	-

Ph: 09 426 6552
Web: www.aspireconsulting.co.nz

CONTOUR DRAIN SPACING	
SLOPE OF SITE (%)	SPACING (m) OF CONTOUR DRAINS
LESS THAN 5%	50
5 - 10%	40
10 - 15%	30
15 - 30%	20

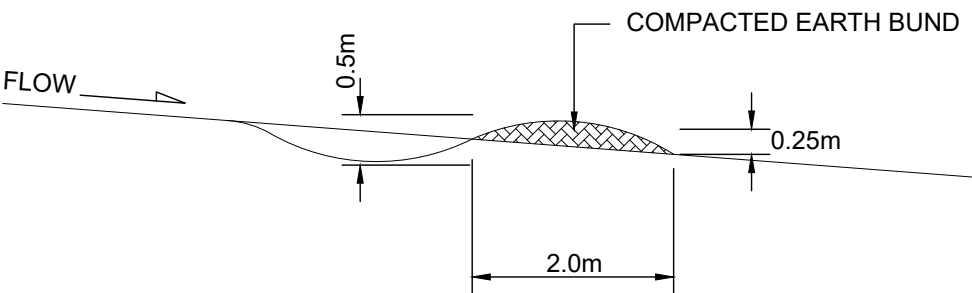

CONTOUR DRAIN CROSS-SECTION

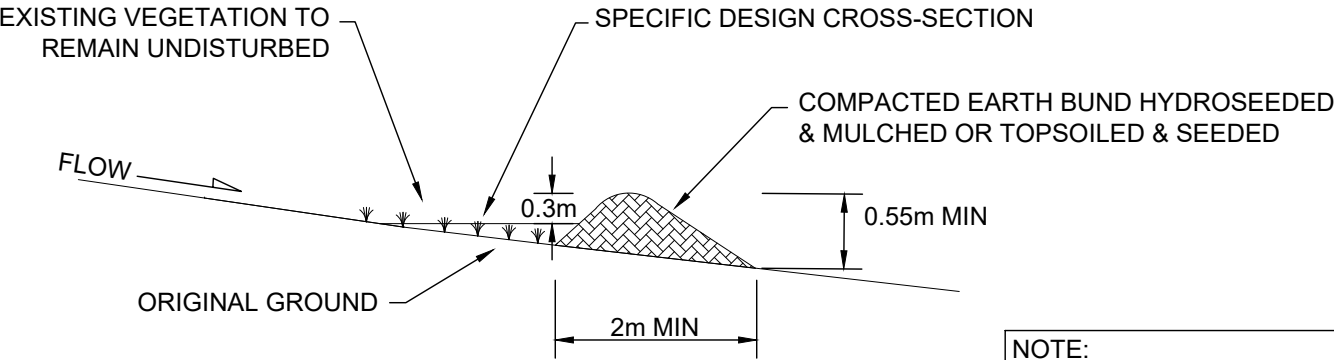


CLEAN WATER DIVERSION CROSS-SECTION

NOTE:

- THE DIVERSION CHANNELS SHOULD BE PARABOLIC OR TRAPEZOIDAL IN SHAPE
- ENSURE INTERNAL SIDES OF THE BUND ARE NO STEEPER THAN 3:1, AND EXTERNAL SIDES NO STEEPER THAN 2:1, AS OUTLINED BELOW

DIRTY WATER DIVERSION
FOR CONSTRUCTION AND OPERATION OF DIRTY WATER DIVERSION CHANNELS AND BUNDS:

- PLAN AND CONSTRUCT ALL DIRTY WATER DIVERSION WORKS AS PART OF THE INITIAL SITE ESTABLISHMENT/ DEVELOPMENT ACTIVITIES
- DEFINE THE ROUTE AND SURVEY IT TO ACHIEVE THE CORRECT GRADIENT
- CONSTRUCT DRAINS WITH A UNIFORM GRADE ALONG THE INVERT, AS SUDDEN DECREASES MAY CAUSE SEDIMENT TO ACCUMULATE CAUSING THE BANK TO OVERTOP
- ENSURE THE BUNDS ASSOCIATED WITH THE DIVERSIONS ARE WELL COMPACTED AND STABILISED. IN SOME INSTANCES, THIS MAY REQUIRE SPECIFIC GEOTECHNICAL DESIGN TO ENSURE THE STABILITY AND INTEGRITY OF THE STRUCTURE
- MONITOR DIVERSIONS FOR EROSION. SUBJECT TO THE SOILS ON SITE IT IS LIKELY THAT EROSION CONTROL WILL BE NEEDED WHERE THE GRADIENTS ARE GREATER THAN 2% OR WHERE THE DESIGN VELOCITIES EXCEED 1m/SEC
- ENSURE THE FINISHED CROSS-SECTION MEETS ALL DESIGN REQUIREMENTS
- PROVIDE AN ADEQUATE OUTLET FOR EACH DIVERSION (i.e DIRTY WATER TO A SEDIMENT CONTROL DEVICE).

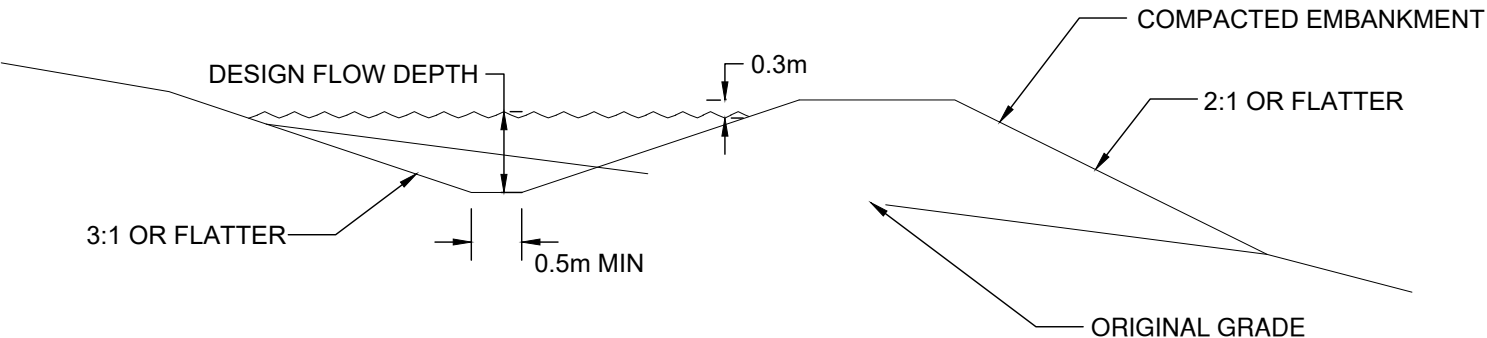


DIRTY WATER DIVERSION CROSS-SECTION

NOTE: BASED ON 0.5m WIDE BASE WITH 1:3 SIDE SLOPES


REV.	DESCRIPTION	CHECK	APP'D	DATE	SCALE	N.T.S	NAME	DATE	CLIENT	SITE ADDRESS	DRAWING NUMBER	DATE	REVISION	<div>ASPIRE CONSULTING ENGINEERS Ph: 09 426 6552 Web: www.aspireconsulting.co.nz</div>
									EAST COAST HEIGHTS LIMITED	PROPOSED 17 LOT RESIDENTIAL SUBDIVISION 53 SMALL ROAD, SILVERDALE	1927 - RC - EW205	MAR 2025	-	
									Conditions of Use: These drawings shall only be used for the purpose for which they were supplied. Do not measure off this drawing. If doubt please contact Engineer.	DRAWING TITLE	PROPOSED EROSION & SEDIMENT CONTROL DETAILS 2			

Slope steepness %	Slope length (m) (maximum)	Spacing of returns (m)	Silt fence length (m) (maximum)
Flatter than 2%	Unlimited	N/A	Unlimited
2 – 10%	40	60	300
10 – 20%	30	50	230
20 – 33%	20	40	150
33 – 50%	15	30	75
> 50%	6	20	40


SILT FENCE DESIGN CRITERIA TABLE

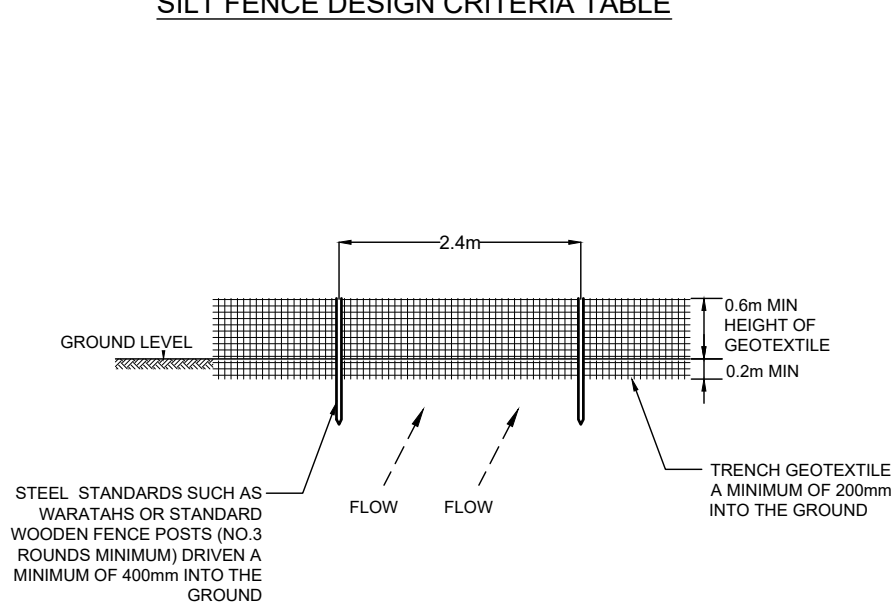

SILT FENCE ELEVATION

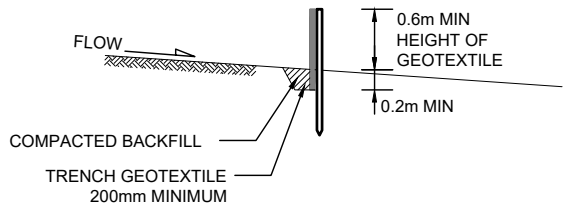

SILT FENCE CROSS-SECTION

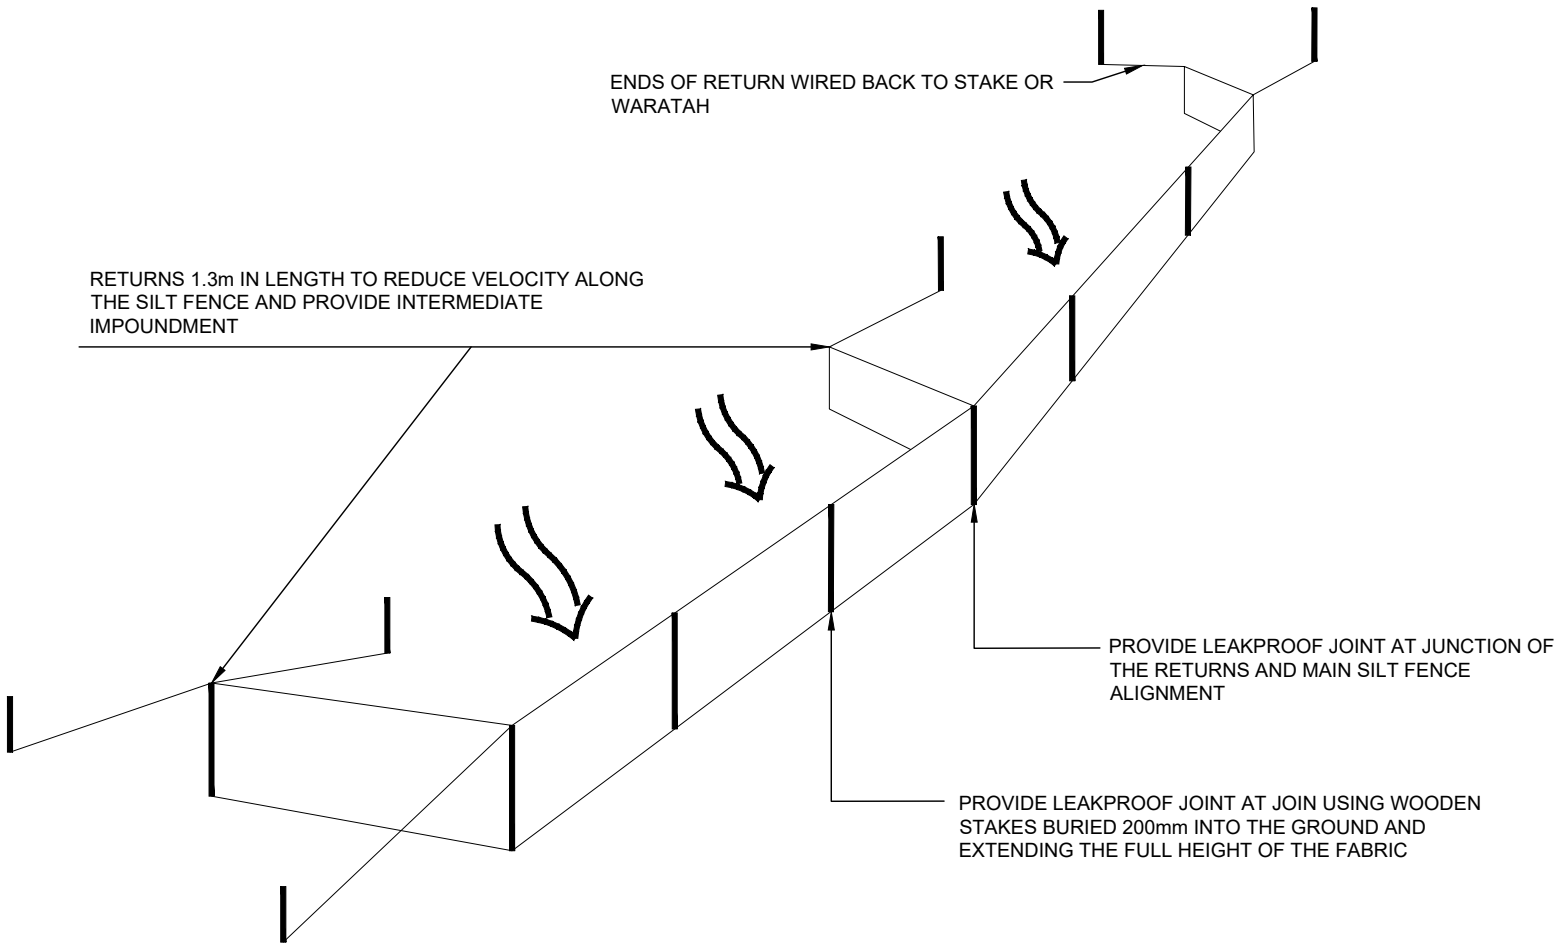


SILT FENCE WITH RETURNS AND SUPPORT WIRE

REV.	DESCRIPTION	CHECK	APP'D	DATE	SCALE	N.T.S
					DESIGN	MJ 03 2025
					DRAWN	KC 03 2025
					DRAWING CHECK	MJ 03 2025
					DESIGN CHECK	MJ 03 2025
					APPROVED	EP 03 2025


CLIENT	EAST COAST HEIGHTS LIMITED
SITE ADDRESS	PROPOSED 17 LOT RESIDENTIAL SUBDIVISION 53 SMALL ROAD, SILVERDALE
DRAWING TITLE	PROPOSED EROSION & SEDIMENT CONTROL DETAILS 3

DRAWING NUMBER	1927 - RC - EW206
DATE	MAR 2025
REVISION	-


Ph: 09 426 6552 Web: www.aspireconsulting.co.nz

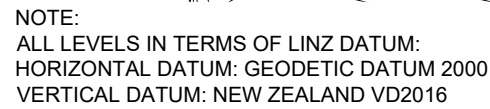

REV.	DESCRIPTION	CHECK	APP'D	DATE	SCALE 1:500 AT A3			CLIENT EAST COAST HEIGHTS LIMITED Conditions of Use: These drawings shall only be used for the purpose for which they were supplied. Do not measure off this drawing. If doubt please contact Engineer.	SITE ADDRESS PROPOSED 17 LOT RESIDENTIAL SUBDIVISION 53 SMALL ROAD, SILVERDALE	DRAWING NUMBER	
A	PLATFORM LEVELS RAISED, WALL HEIGHTS UPDATED	MJ	PF	24.9.25		NAME	DATE			1927 - RC - EW207	
					DESIGN	MJ	03.25			DATE	REVISION
					DRAWN	KC	03.25				
					DRAWING CHECK	MJ	03.25				
					DESIGN CHECK	MJ	03.25				
					APPROVED	PF	03.25	DRAWING TITLE		MAR 2025	A
								PROPOSED RETAINING WALL PLAN			



Ph: 09 426 6552
Web: www.aspireconsulting.co.nz

LEGEND

PROPOSED POWER

PROPOSED TELECOM

PROPOSED TACTILE



EXISTING CESSPIT

PROPOSED FOOTPATH/
CYCLE LANE

EXISTING PRAM CROSSING
TO BE RELOCATED

NOT FOR CONSTRUCTION

FOR RESOURCE CONSENT PURPOSE

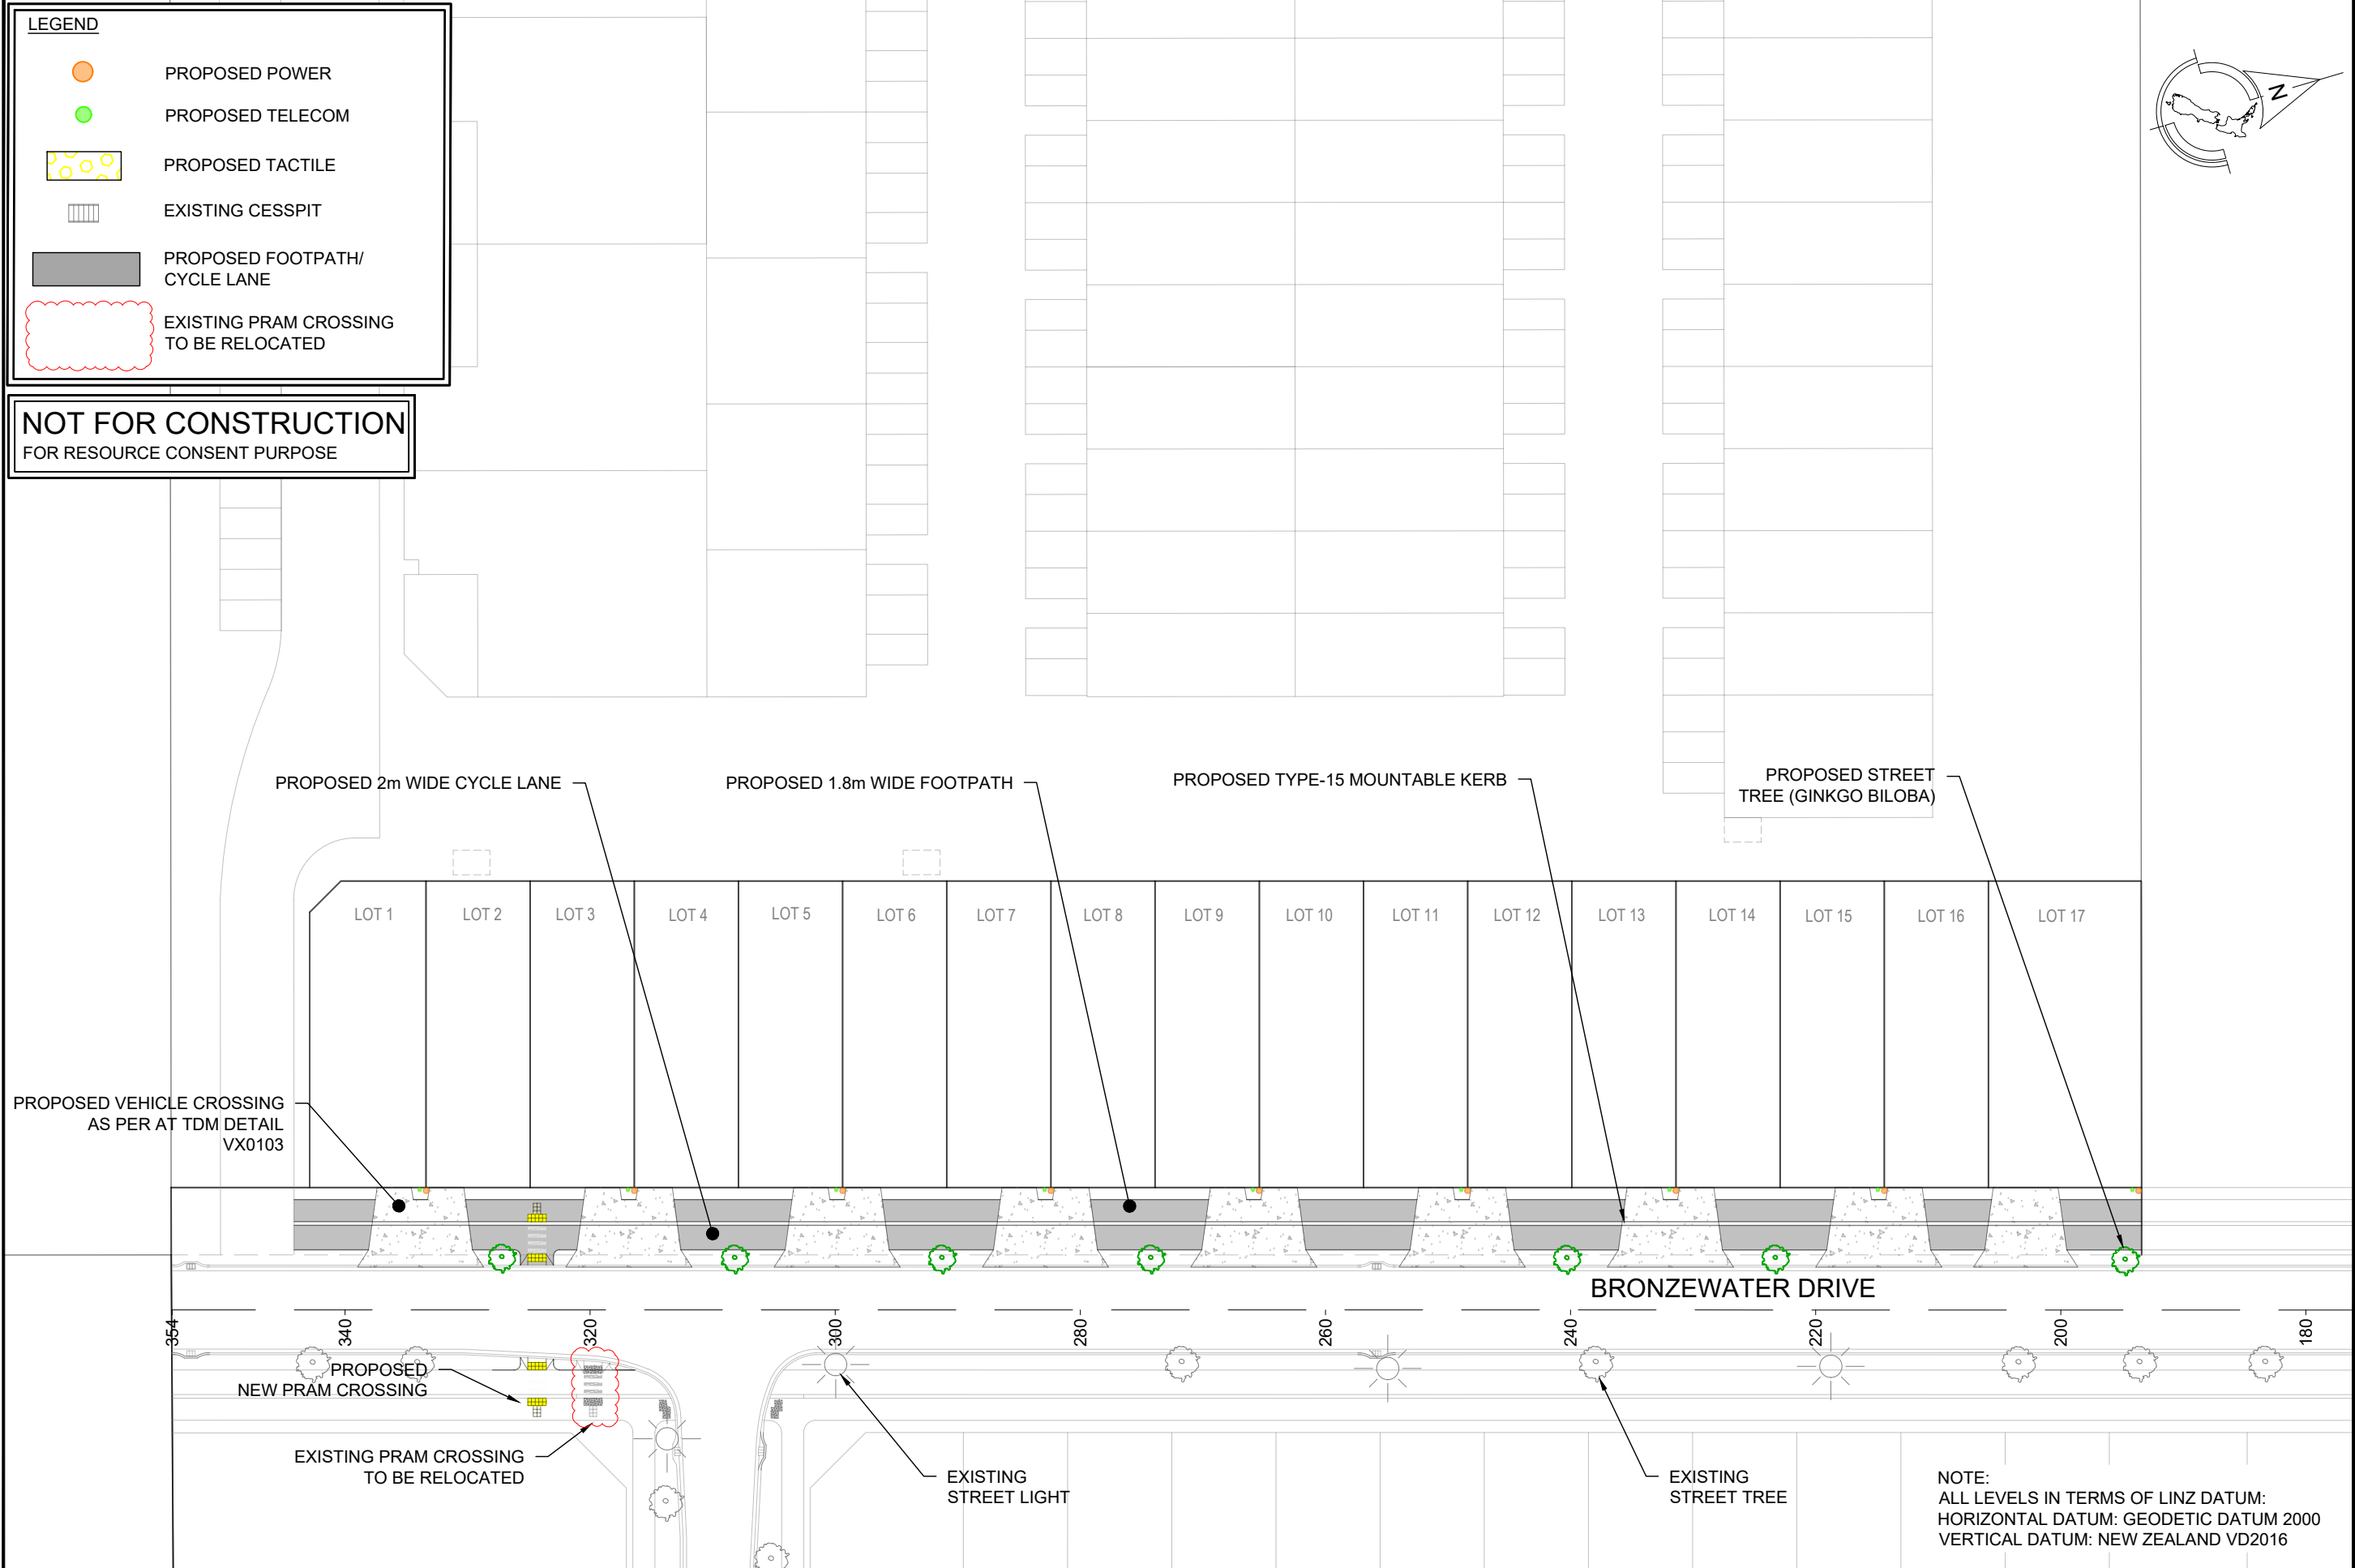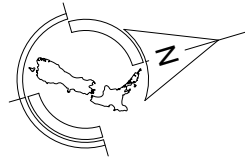

REV.	DESCRIPTION	CHECK	APP'D	DATE	SCALE	1:500 AT A3
A	PROPOSED STREET TREES & EXISTING TREES & LIGHTS ADDED	KC	MJ	08.25		
					DESIGN	MJ 03.25
					DRAWN	KC 03.25
					DRAWING CHECK	MJ 03.25
					DESIGN CHECK	MJ 03.25
					APPROVED	PF 03.25

CLIENT

EAST COAST HEIGHTS LIMITED

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SITE ADDRESS

PROPOSED 17 LOT RESIDENTIAL SUBDIVISION
53 SMALL ROAD,
SILVERDALE

DRAWING TITLE

PROPOSED ROADING PLAN

DRAWING NUMBER

1927 - RC - RD301

DATE

MAR 2025

REVISION


A

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REV.	DESCRIPTION	CHECK	APP'D	DATE	SCALE	1:100 AT A3
A	FRONT BERM UPDATED	KC	MJ	08.25		
					NAME	DATE
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					KC	03.25
					MJ	03.25
					MJ	03.25
					PF	03.25


CLIENT
EAST COAST HEIGHTS LIMITED
Conditions of Use: These drawings shall only be used for the purpose for which they were supplied. Do not measure off this drawing. If doubt please contact Engineer.

SITE ADDRESS
PROPOSED 17 LOT RESIDENTIAL SUBDIVISION 53 SMALL ROAD, SILVERDALE
DRAWING TITLE
TYPICAL VEHICLE CROSSING DETAIL

DRAWING NUMBER
1927 - RC - RD302
DATE
MAR 2025
REVISION
A
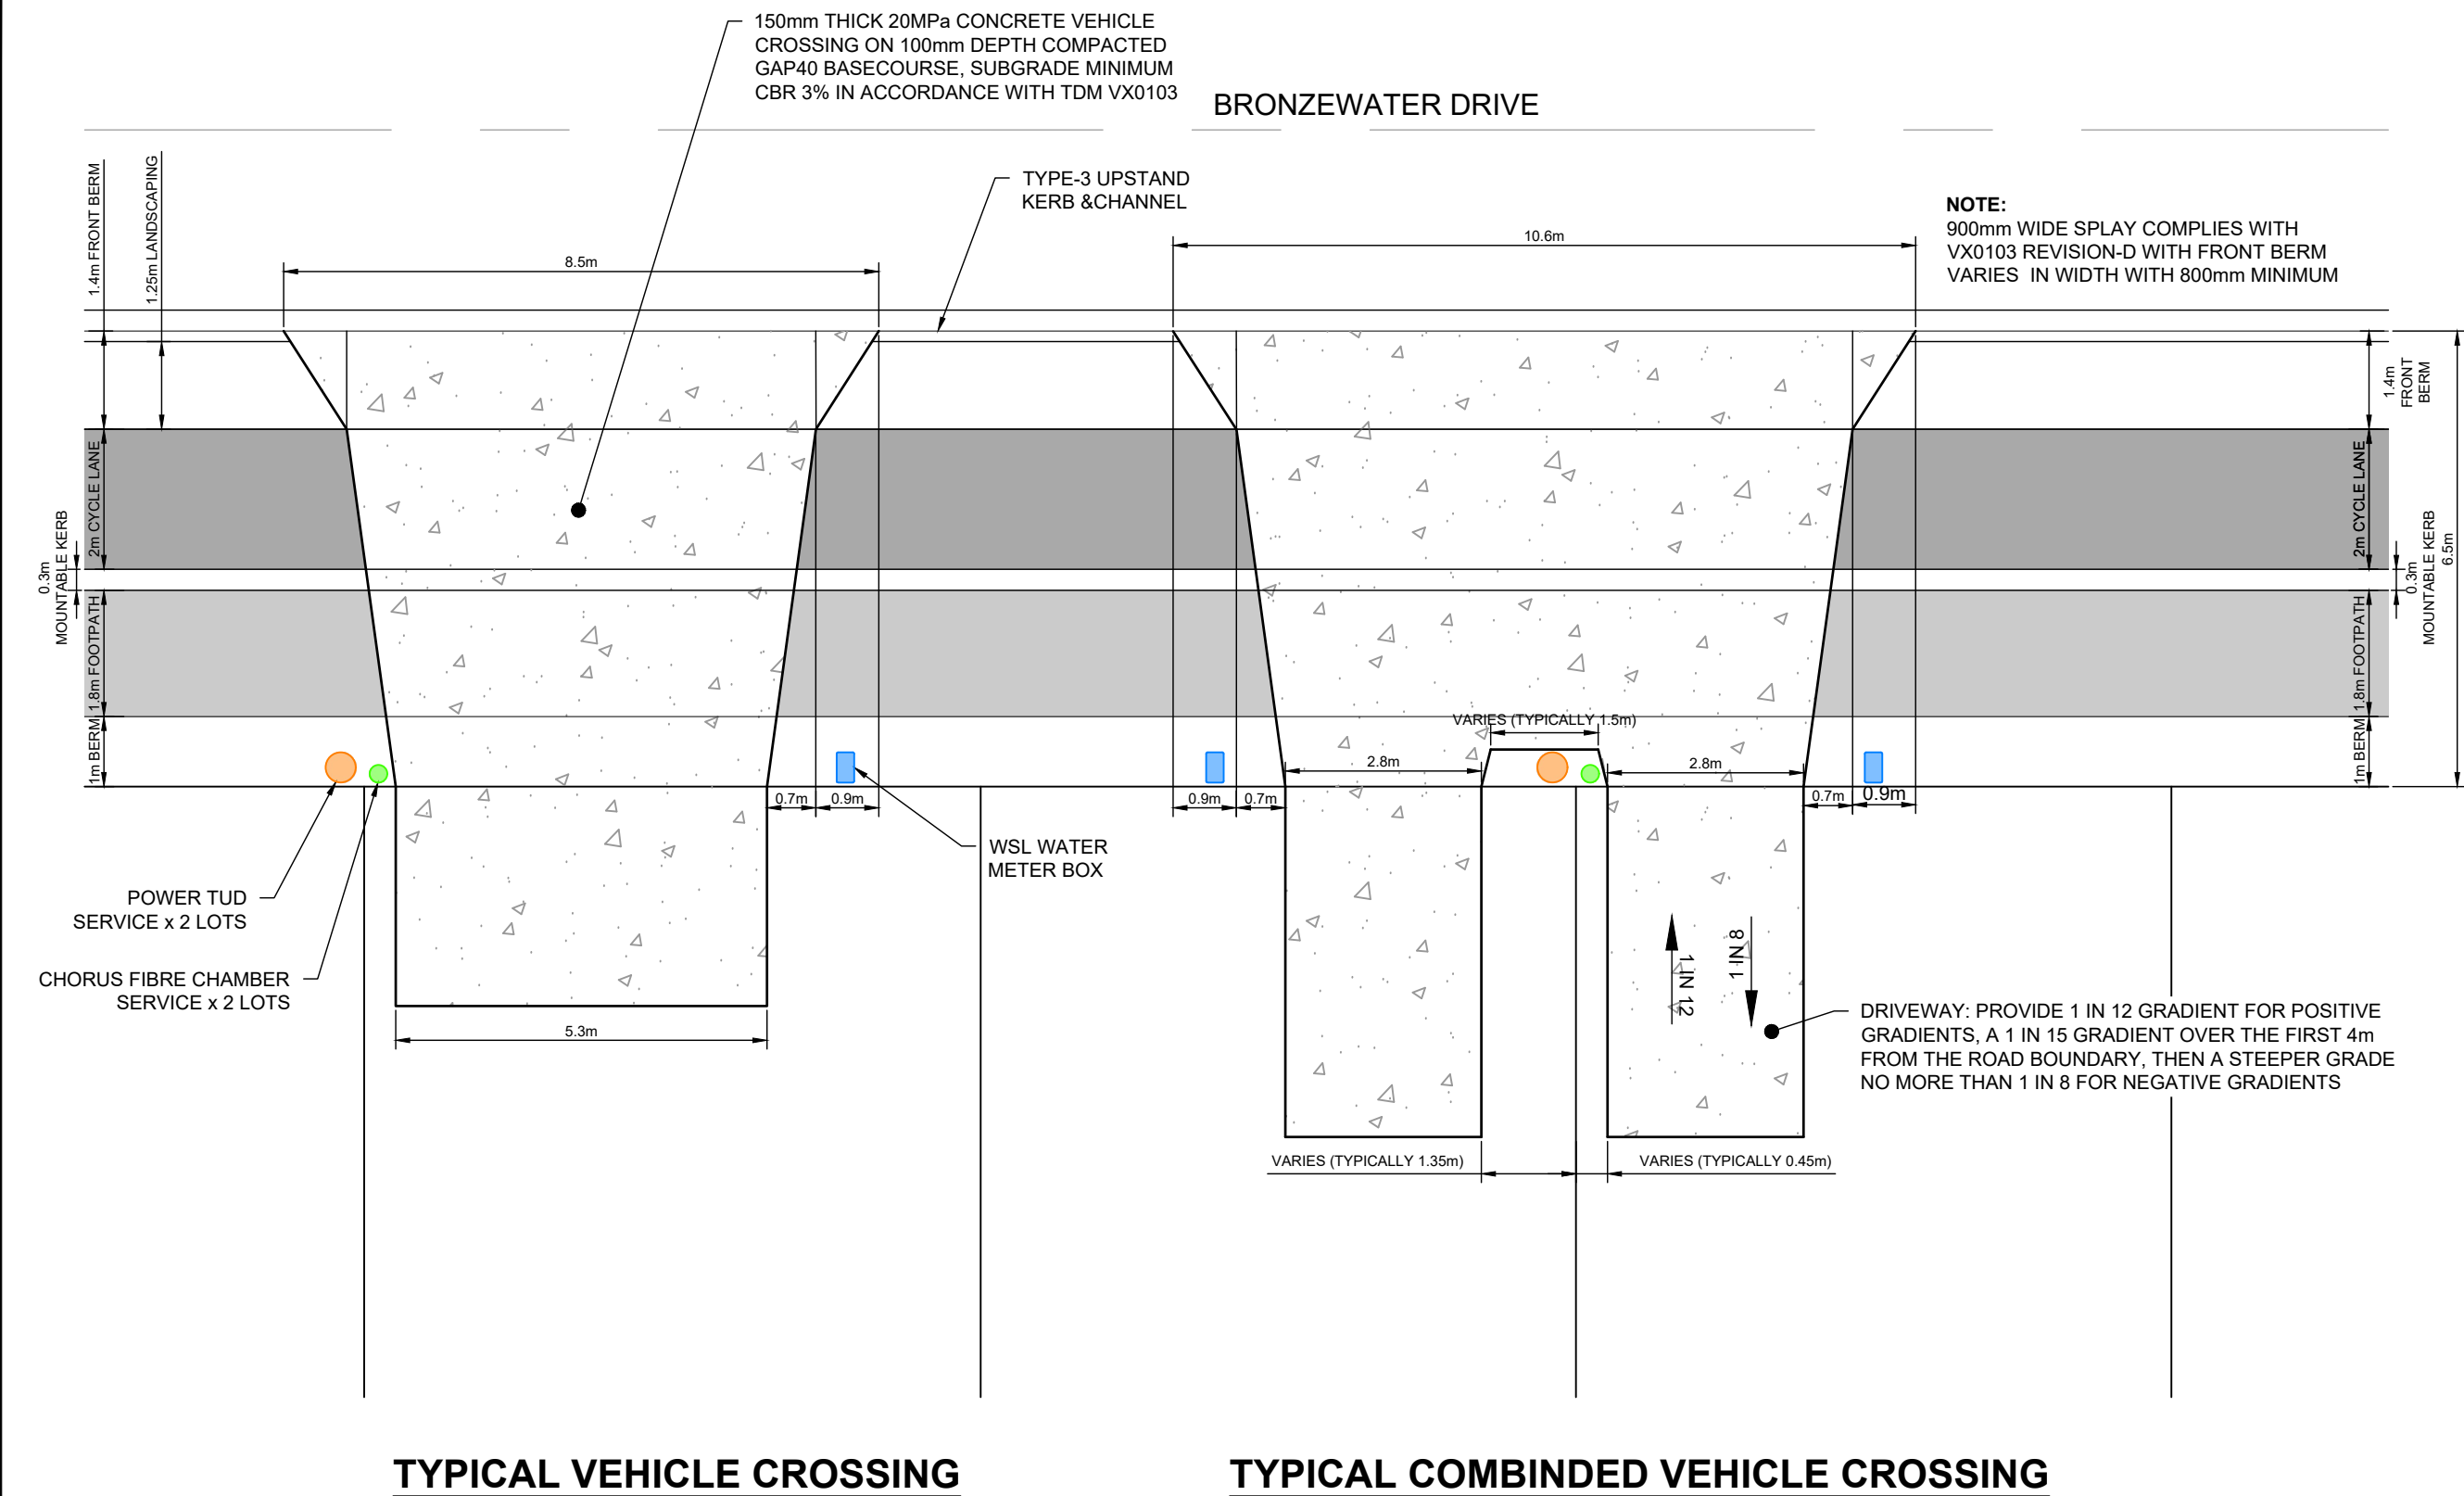
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CONSULTING ENGINEERS

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**TYPICAL BRONZEWATER DRIVE SECTION
WITH CYCLEPATH & FOOTPATH**

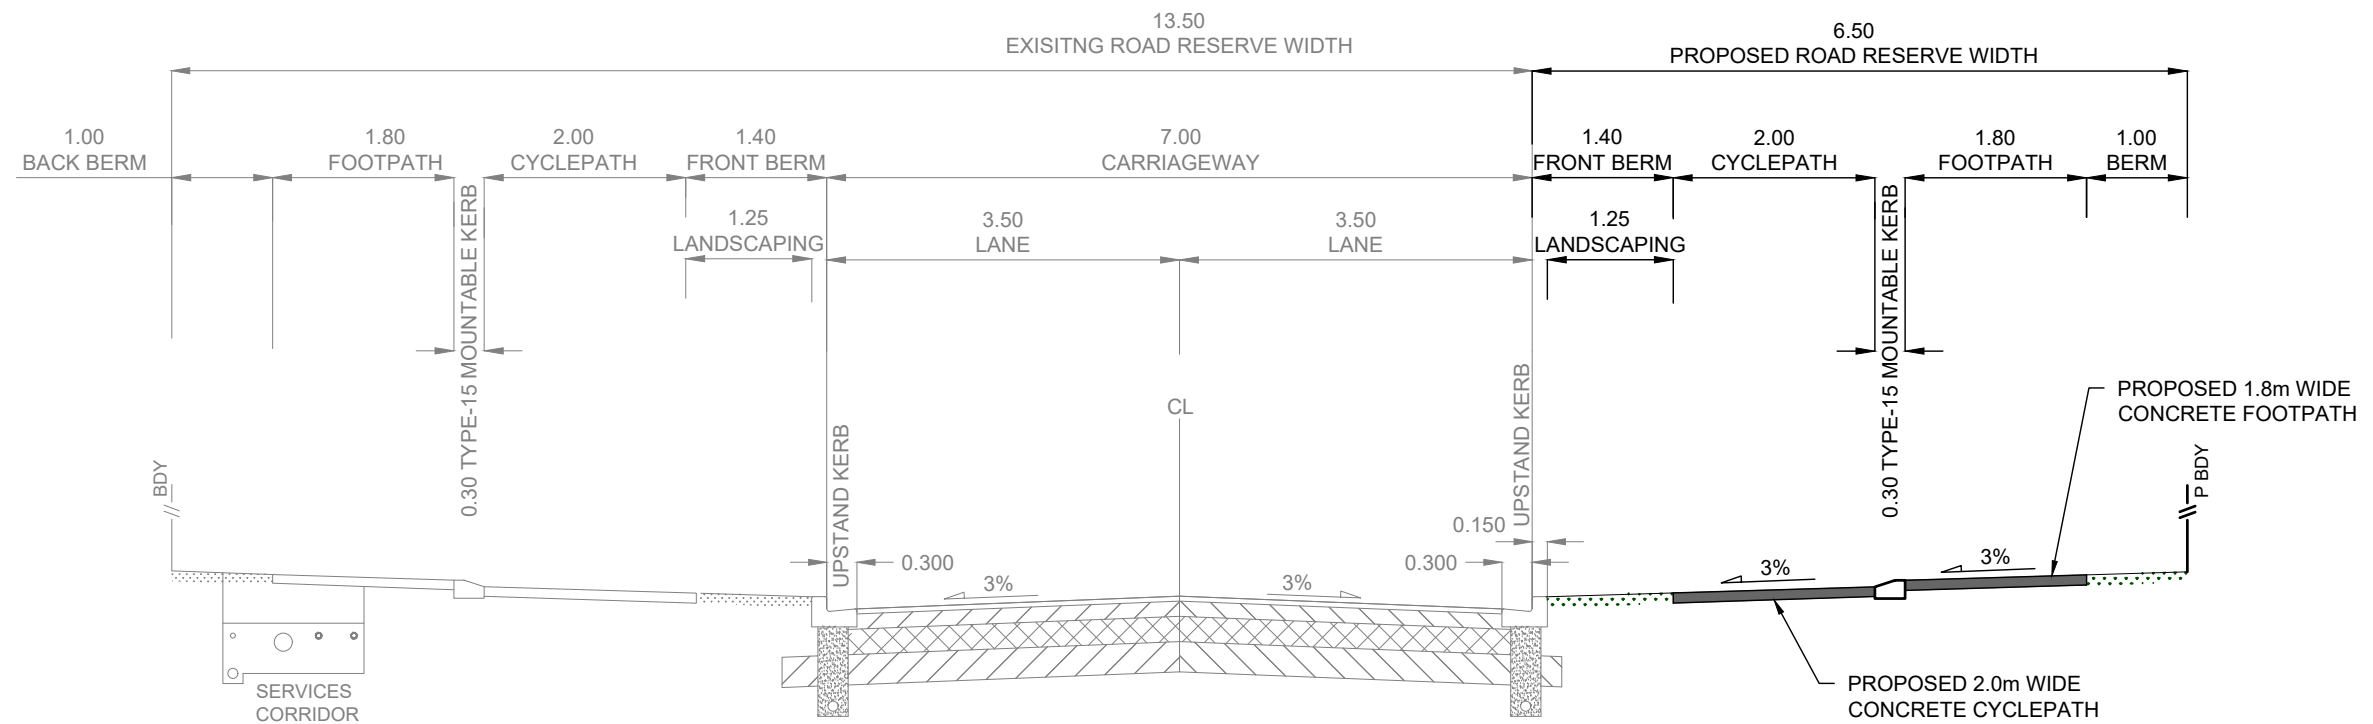NOTE:
ALL LEVELS IN TERMS OF LINZ DATUM:
HORIZONTAL DATUM: GEODETIC DATUM 2000
VERTICAL DATUM: NEW ZEALAND VD2016

NOT FOR CONSTRUCTION
FOR RESOURCE CONSENT PURPOSE

REV.	DESCRIPTION	CHECK	APP'D	DATE	SCALE	1:75 AT A3
A	FRONT BERM UPDATED	KC	MJ	08.25		
					NAME	DATE
					DESIGN	MJ 03.25
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					DRAWING CHECK	MJ 03.25
					DESIGN CHECK	MJ 03.25
					APPROVED	PF 03.25


CLIENT
EAST COAST HEIGHTS LIMITED
Conditions of Use: These drawings shall only be used for the purpose for which they were supplied. Do not measure off this drawing. If doubt please contact Engineer.

SITE ADDRESS
PROPOSED 17 LOT RESIDENTIAL SUBDIVISION 53 SMALL ROAD, SILVERDALE
DRAWING TITLE
PROPOSED TYPICAL ROAD CROSS SECTION PLAN

DRAWING NUMBER
1927 - RC - RD303
DATE
MAR 2025
REVISION
A


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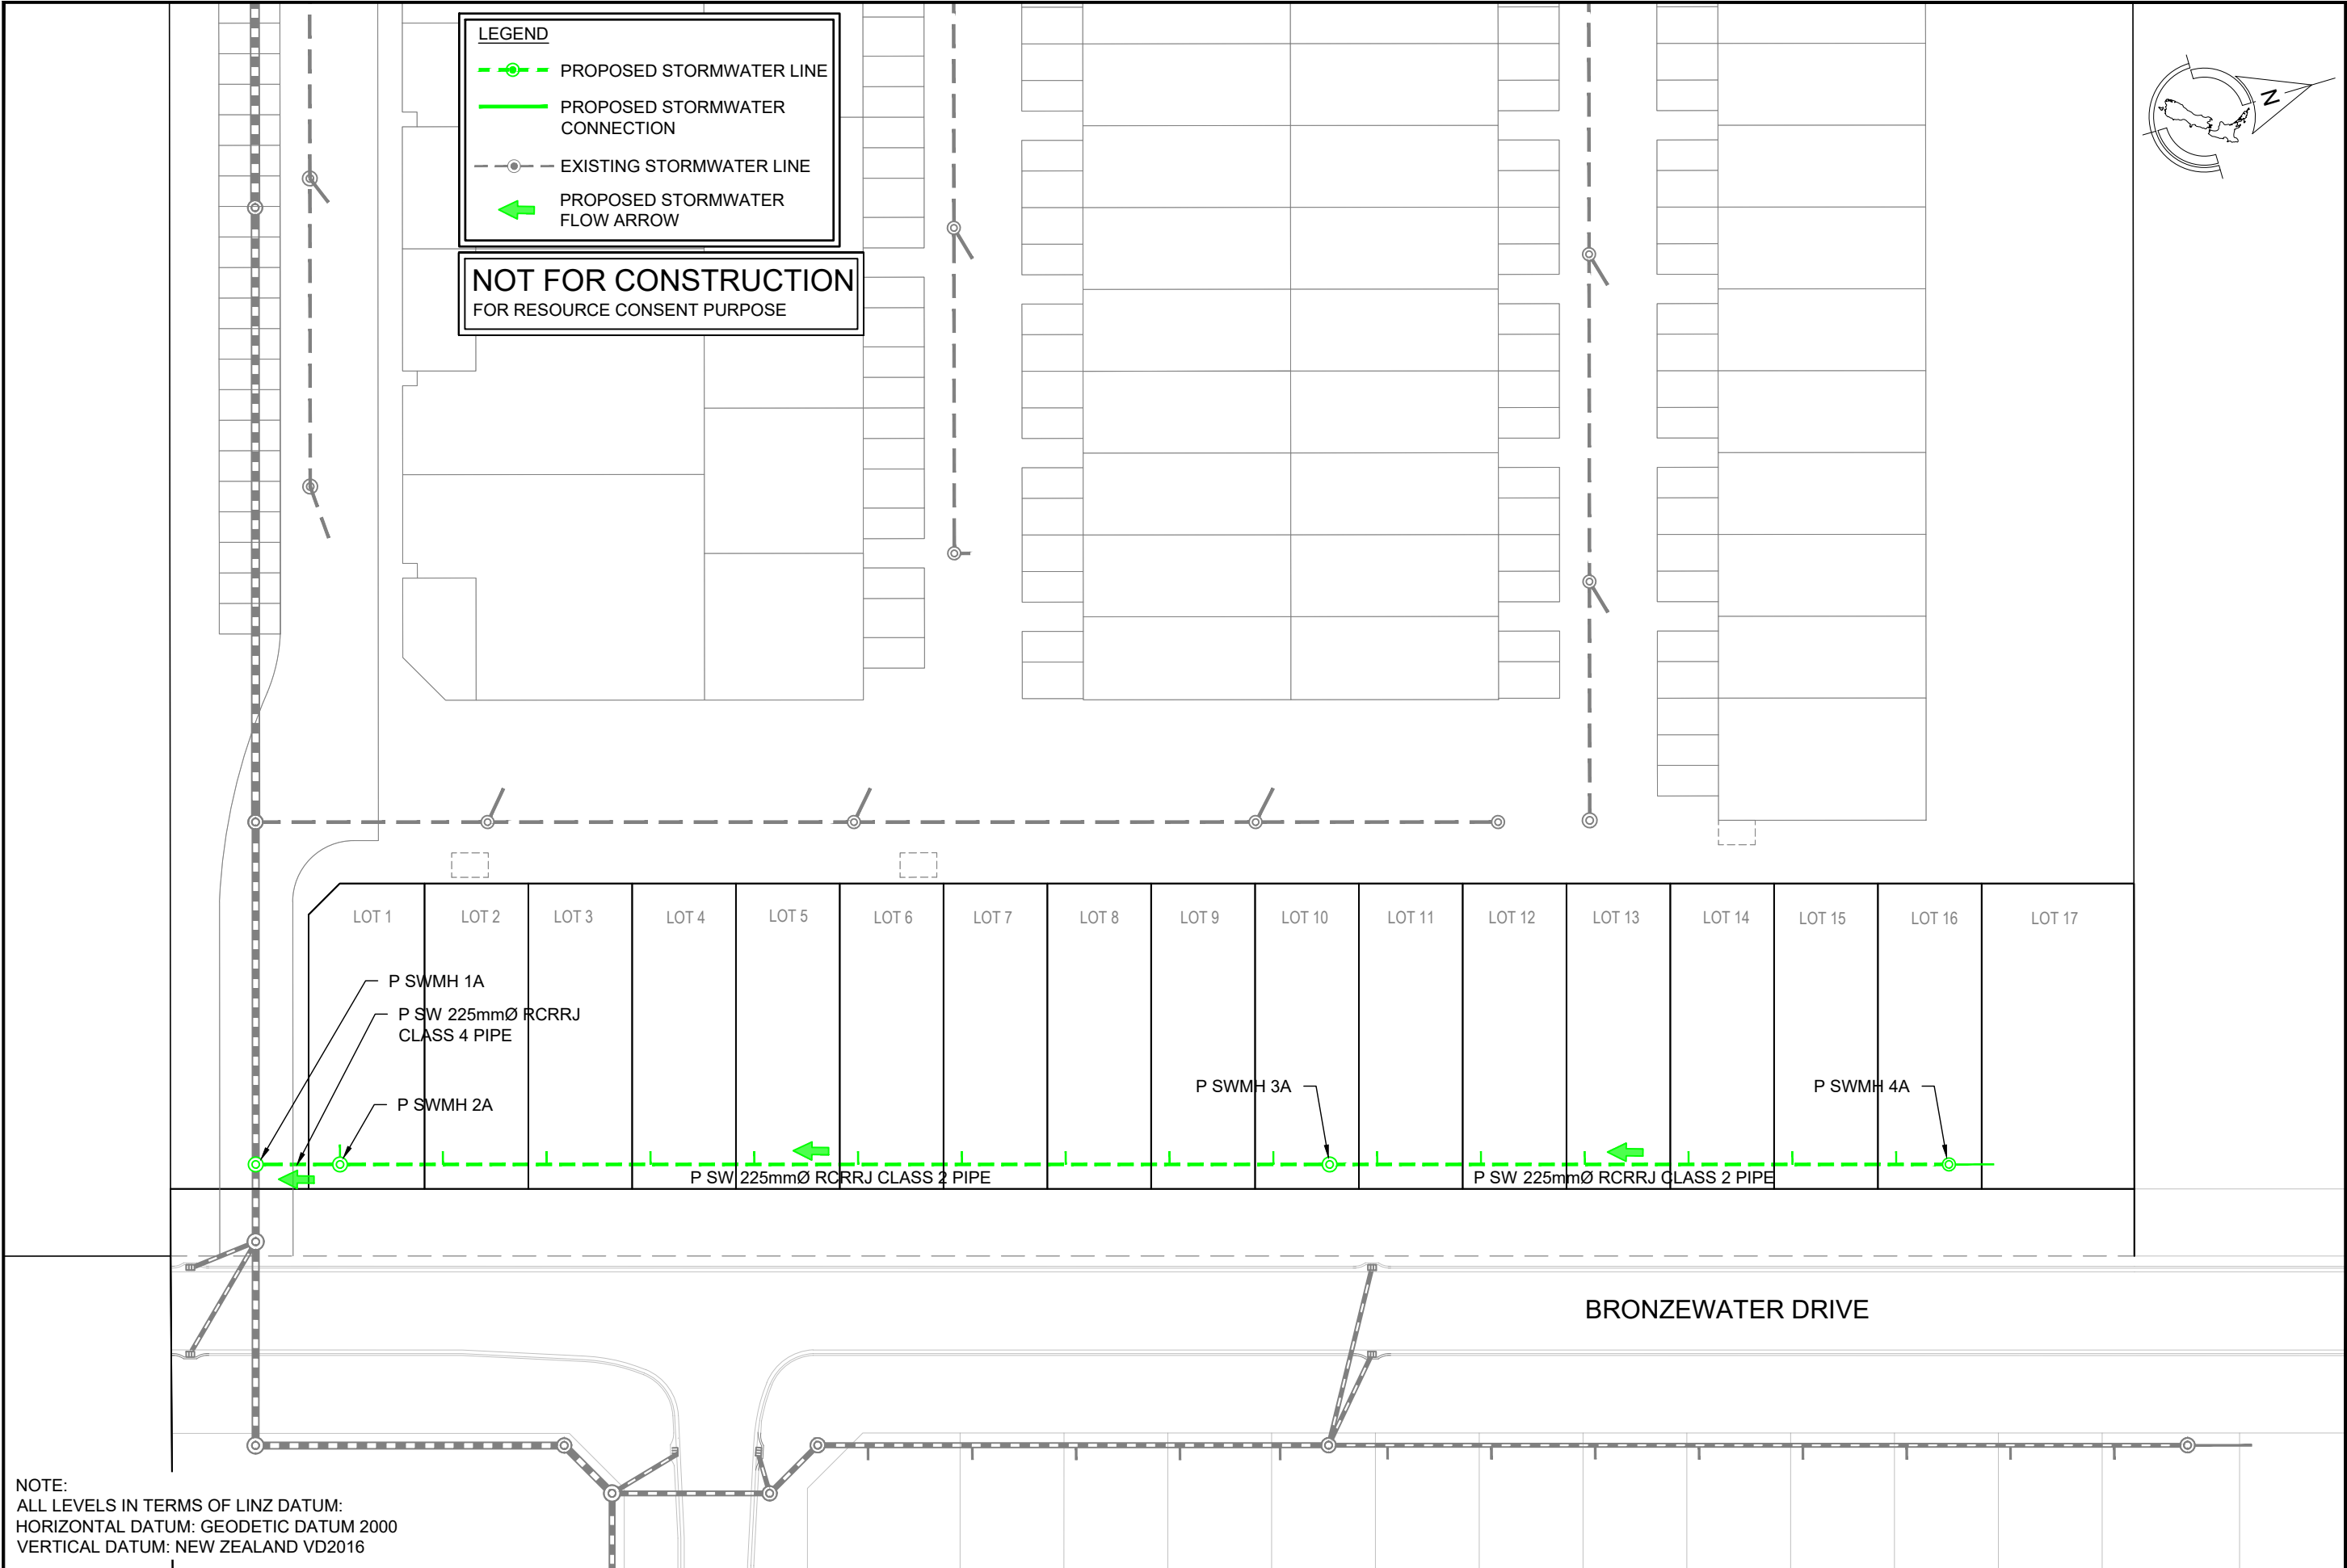


NOTE:
ALL LEVELS IN TERMS OF LINZ DATUM:
HORIZONTAL DATUM: GEODETIC DATUM 2000
VERTICAL DATUM: NEW ZEALAND VD2016

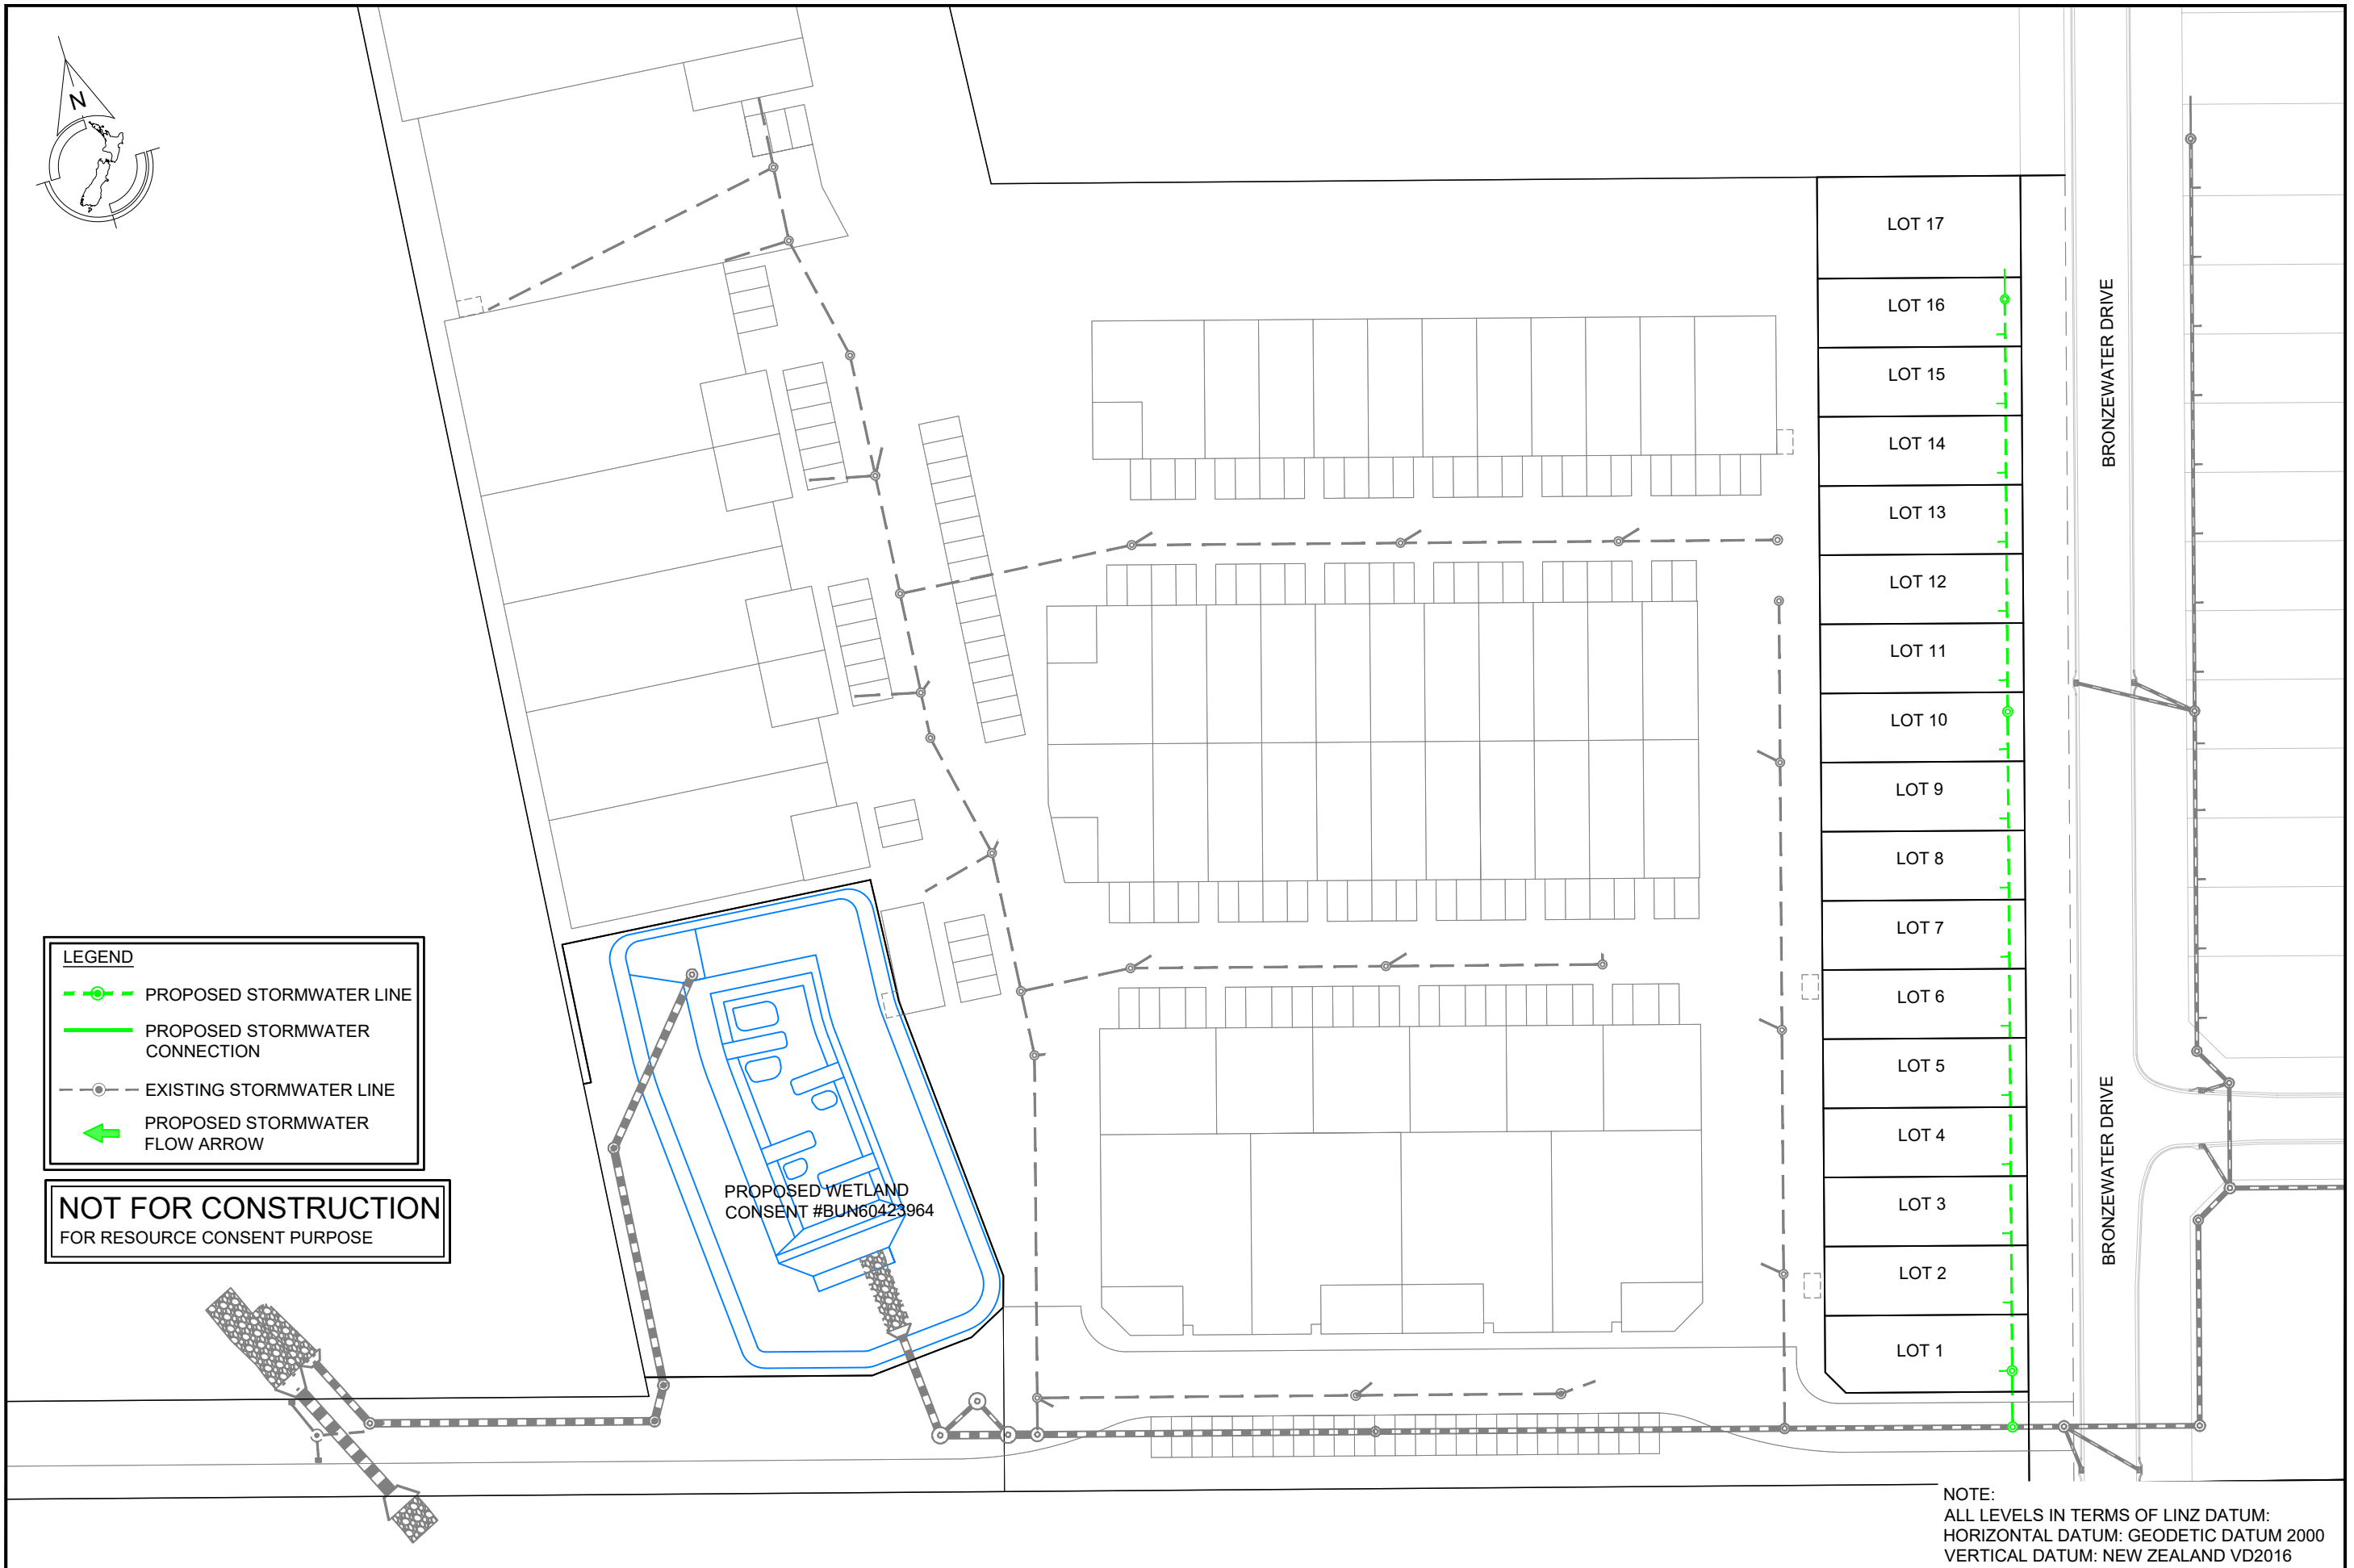
REV.	DESCRIPTION	CHECK	APP'D	DATE	SCALE 1:750 AT A3			CLIENT EAST COAST HEIGHTS LIMITED	SITE ADDRESS PROPOSED 17 LOT RESIDENTIAL SUBDIVISION 53 SMALL ROAD, SILVERDALE	DRAWING NUMBER 1927 - RC - SW401				
						NAME	DATE				DRAWING TITLE PROPOSED STORMWATER OVERVIEW PLAN	DATE MAR 2025	REVISION -	
						DESIGN	MJ							03.25
						DRAWN	KC							03.25
						DRAWING CHECK	MJ							03.25
						DESIGN CHECK	MJ	03.25						
						APPROVED	PF	03.25						
Conditions of Use: These drawings shall only be used for the purpose for which they were supplied. Do not measure off this drawing. If doubt please contact Engineer.														



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NOTE:
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HORIZONTAL DATUM: GEODETIC DATUM 2000
VERTICAL DATUM: NEW ZEALAND VD2016

REV.		DESCRIPTION		CHECK	APP'D	DATE	SCALE 1:500 AT A3		CLIENT		SITE ADDRESS		DRAWING NUMBER		<div></div> <div>Ph: 09 426 6552 Web: www.aspireconsulting.co.nz</div>		
									EAST COAST HEIGHTS LIMITED		PROPOSED 17 LOT RESIDENTIAL SUBDIVISION 53 SMALL ROAD, SILVERDALE		1927 - RC - SW402				
													DATE			REVISION	
													MAR 2025			-	
									<div>Conditions of Use: These drawings shall only be used for the purpose for which they were supplied. Do not measure off this drawing. If doubt please contact Engineer.</div>		DRAWING TITLE PROPOSED STORMWATER PLAN						



LEGEND

- PROPOSED WASTEWATER PIPE
- PROPOSED WASTEWATER CONNECTION
- EXISTING WASTEWATER LINE
- PROPOSED WASTEWATER FLOW ARROW

NOT FOR CONSTRUCTION
FOR RESOURCE CONSENT PURPOSE

NOTE:
ALL LEVELS IN TERMS OF LINZ DATUM:
HORIZONTAL DATUM: GEODETIC DATUM 2000
VERTICAL DATUM: NEW ZEALAND VD2016

REV.	DESCRIPTION	CHECK	APP'D	DATE	SCALE	1:750 AT A3
					NAME	DATE
					DESIGN	MJ 03.25
					DRAWN	KC 03.25
					DRAWING CHECK	MJ 03.25
					DESIGN CHECK	MJ 03.25
					APPROVED	PF 03.25

CLIENT
EAST COAST HEIGHTS LIMITED
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SITE ADDRESS
PROPOSED 17 LOT RESIDENTIAL SUBDIVISION 53 SMALL ROAD, SILVERDALE
DRAWING TITLE
PROPOSED WASTEWATER OVERVIEW PLAN

DRAWING NUMBER
1927 - RC - WW501
DATE
MAR 2025
REVISION
-

ASPIRE
CONSULTING ENGINEERS

Ph: 09 426 6552
Web: www.aspireconsulting.co.nz

LOT 17

LOT 16

LOT 15

LOT 14

LOT 13

LOT 12

LOT 11

LOT 10

LOT 9

LOT 8

LOT 7

LOT 6

LOT 5

LOT 4

LOT 3

LOT 2

LOT 1

BRONZEWATER DRIVE

BRONZEWATER DRIVE




NOT FOR CONSTRUCTION
FOR RESOURCE CONSENT PURPOSE

LEGEND

EXISTING WATER SUPPLY LINE

EXISTING WATER METER

PROPOSED WATER METER

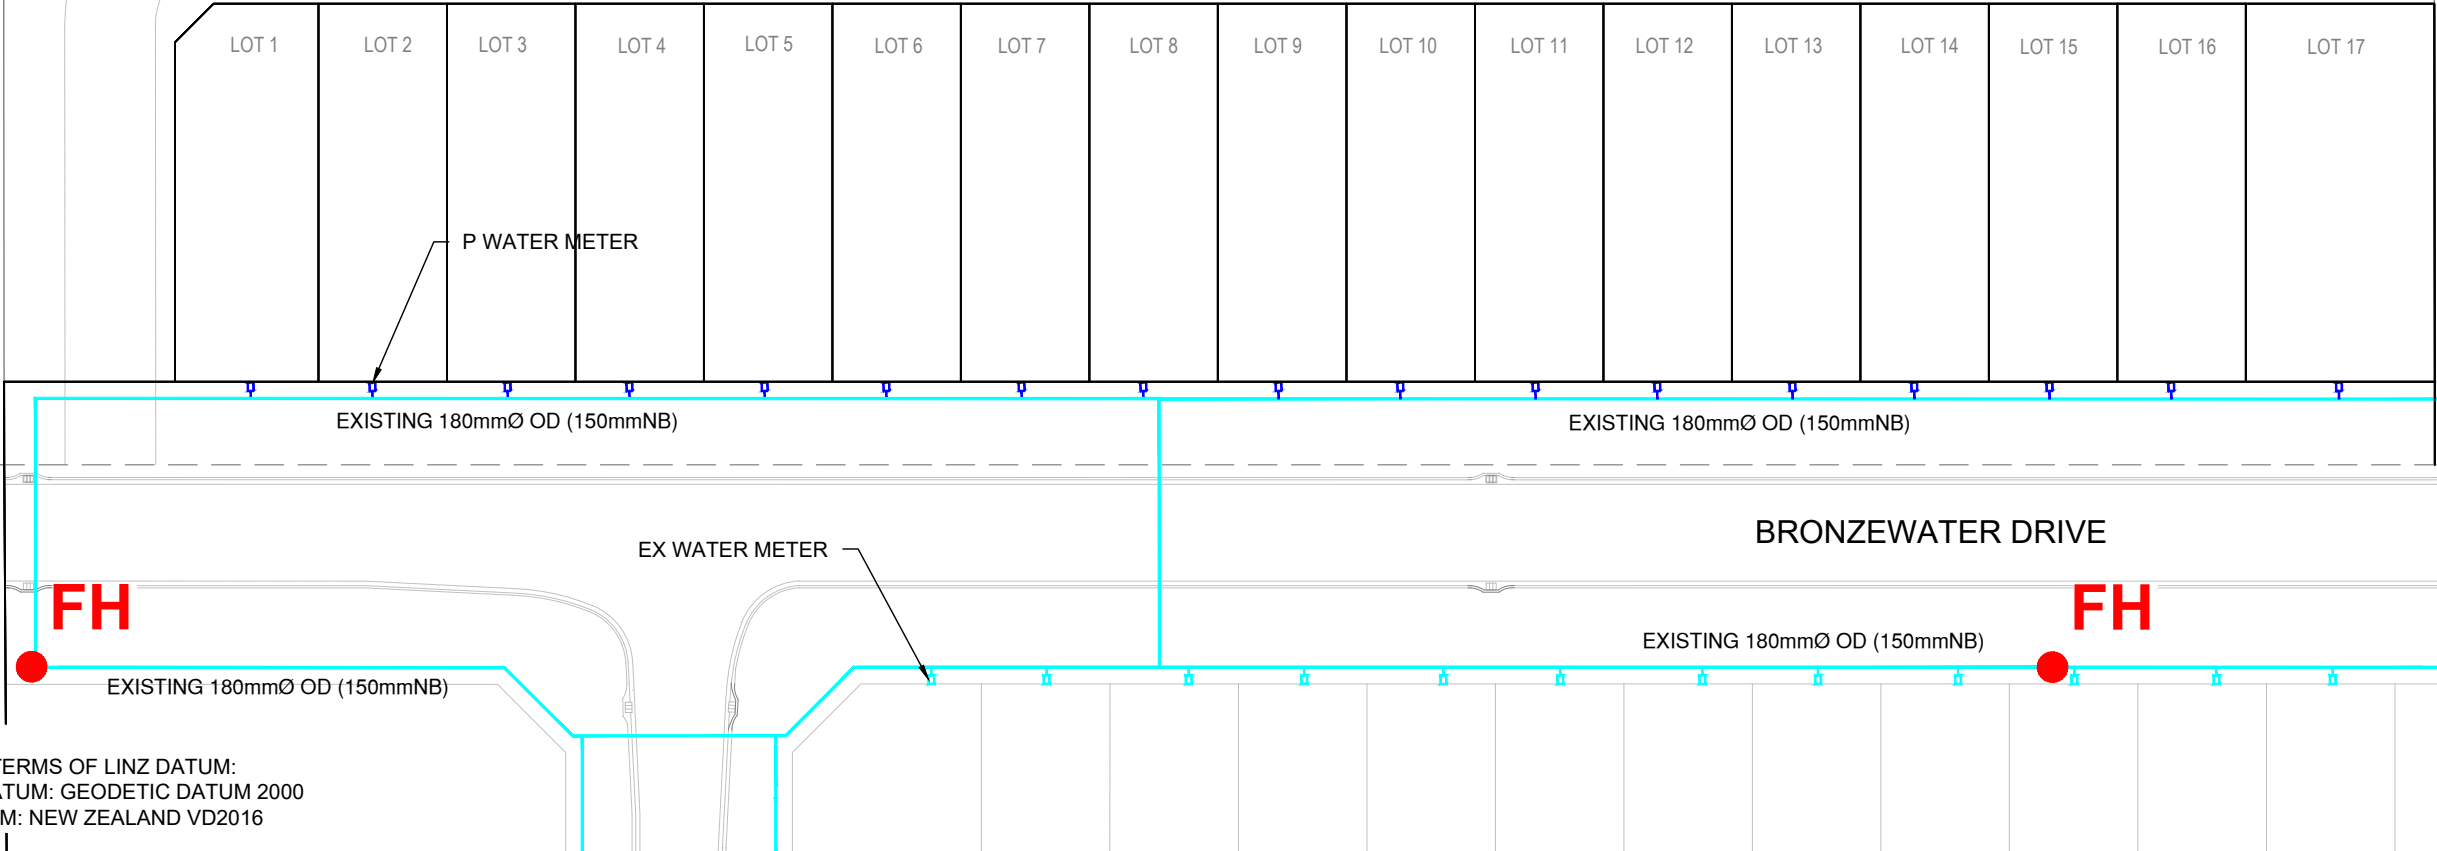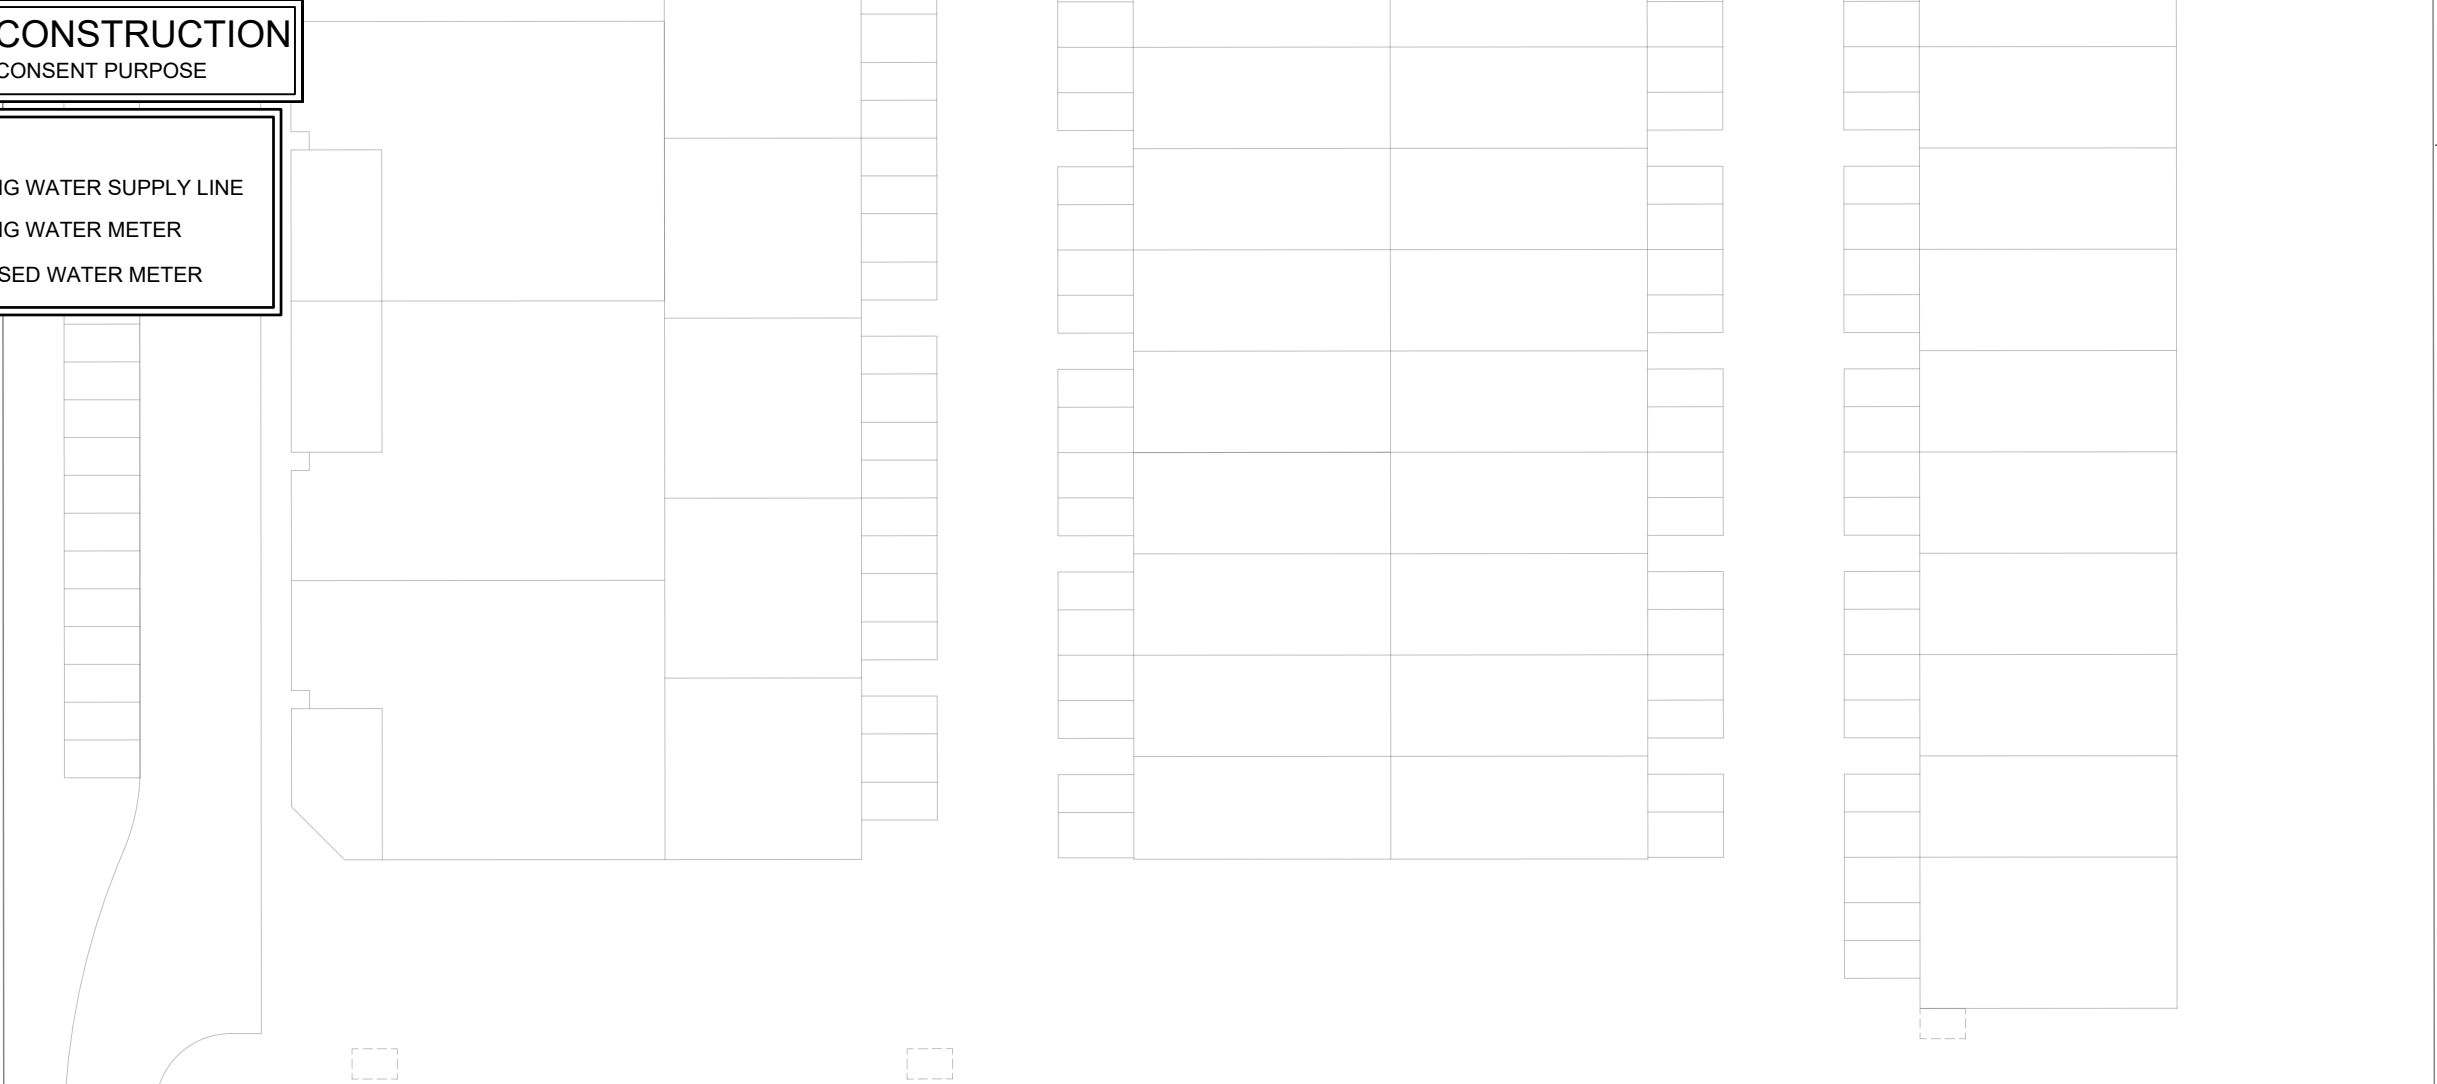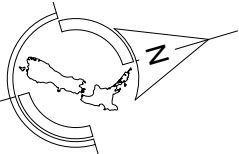

NOTE:
ALL LEVELS IN TERMS OF LINZ DATUM:
HORIZONTAL DATUM: GEODETIC DATUM 2000
VERTICAL DATUM: NEW ZEALAND VD2016

REV.	DESCRIPTION	CHECK	APP'D	DATE	SCALE	1:500 AT A3
					NAME	DATE
					MJ	03.25
					KC	03.25
					MJ	03.25
					MJ	03.25
					PF	03.25

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SITE ADDRESS

PROPOSED 17 LOT RESIDENTIAL SUBDIVISION
53 SMALL ROAD,
SILVERDALE

DRAWING TITLE

PROPOSED WATER SUPPLY PLAN

DRAWING NUMBER

1927 - RC - WS601

DATE

MAR 2025

REVISION

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